ANNEXURE-5 REVISED

TENDER DRAWINGS

CONSTRUCTION OF INDIA PAVILION FOR THE WORLD EXPO 2025 TO BE HELD IN OSAKA,

JAPAN ON DETAILED DESIGN, ENGINEERING, PROCUREMENT AND CONSTRUCTION BASIS

TOGETHER WITH SERVICES FOR CIVIL, ARCHITECTURAL, ELECTRICAL, PLUMBING, HVAC

OPERATIONS AND MAINTENANCE WORKS DURING THE EXPO AND SUBSEQUENT

DISMANTLING OF THE INDIA PAVILION.




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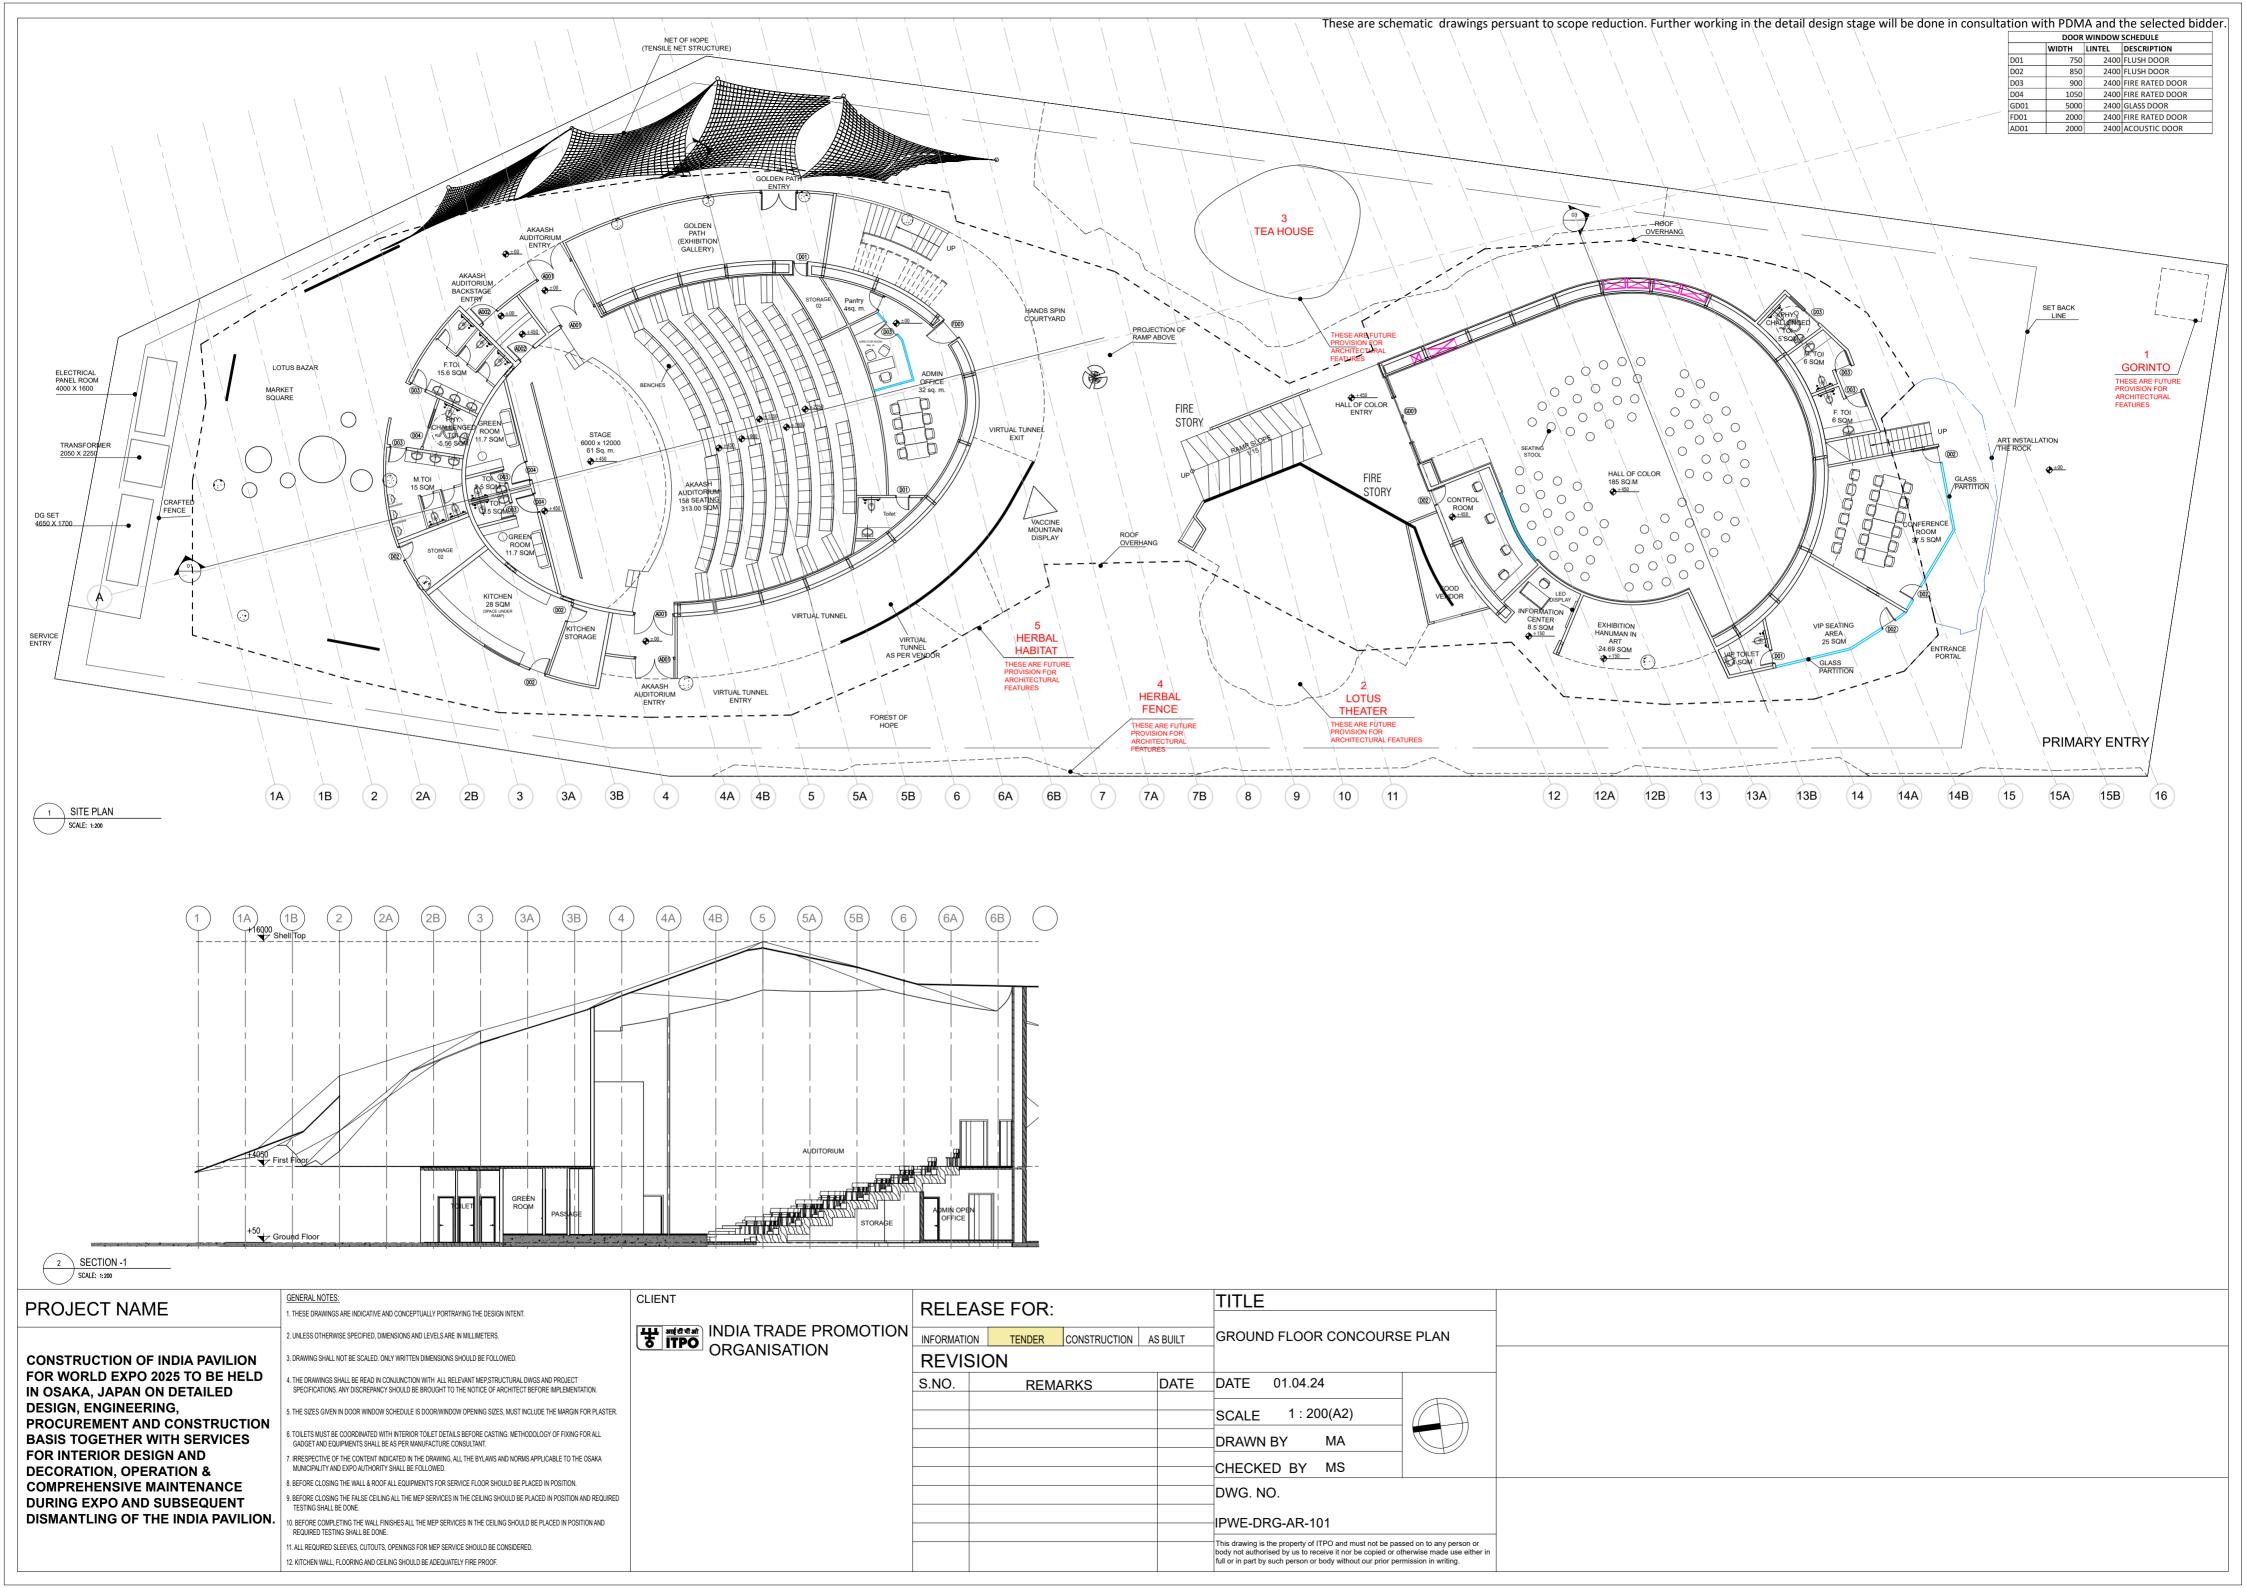
INDIA TRADE PROMOTION ORGANISATION


TENDER DRAWING LIST


S.No.	Drawing No.	Title	SHEET SIZE	SCALE
1	IPWE-DRG-AR-100R	Site Plan	A2	1-200
2	IPWE-DRG-AR-101R	Ground Floor Plan	A2	1-200
3	IPWE-DRG-AR-102R	First Floor Plan	A2	1-200
4	IPWE-DRG-AR-103R	Second Floor Plan	A2	1-200
5	IPWE-DRG-AR-104R	Elevations	A2	1-200
6	IPWE-DRG-AR-101R & 102R	Sections	A2	1-200
7	IPWE-DRG-HVAC-101R	HVAC-Ground Floor Plan	A2	1-200
8	IPWE-DRG-HVAC-102R	HVAC-First Floor Plan	A2	1-200
9	IPWE-DRG-ELE-101R	Lighting Layout - Ground Floor	A2	1-200
10	IPWE-DRG-ELE-102R	Power Layout - Ground Floor	A2	1-200
11	IPWE-DRG-ELE-103R	ELV - Ground Floor	A2	1-200
12	IPWE-DRG-ELE-104R	Fire Alarm - Ground Floor	A2	1-200
13	IPWE-DRG-ELE-101 A-R	Lighting Layout - First Floor	A2	1-200
14	IPWE-DRG-ELE-102 A-R	Power Layout - First Floor	A2	1-200
15	IPWE-DRG-ELE-103 A-R	ELV - First Floor	A2	1-200
16	IPWE-DRG-ELE-104 A-R	Fire Alarm - First Floor	A2	1-200
17	IPWE-DRG-FF-101R	Fire Fighting -Ground Floor Plan	A2	1-200
18	IPWE-DRG-FF-102R	Fire Fighting - First Floor Plan	A2	1-200
19	IPWE-DRG-FF-103R	Fire Fighting - Second Floor Plan	A2	1-200
20	IPWE-DRG-PL-100R	Plumbing - Ground Floor Plan	A2	1-200
21	IPWE-DRG-PL-101R	Plumbing - First Floor Plan	A2	1-200

22	IPWE-DRG-Pth € G2 Pe schematic drawings persuant to sc	op eluedubiing. F என்னால் r klogoin Pla d etail design stage will be done in consulta	tio A 2with PDMA and th	e sel@@d bidder.
23	S-09	Structure - Basic Map	A2	1-200
24	S-10	Structure – Dirt Map	A2	1-200
25	S-11	Structure – Foundation Map	A2	1-200
26	S-12	Structure – First Floor Seismic Wall Map	A2	1-200
27	S-13	Structure – Second Floor Plan	A2	1-200
28	S-14	Structure – Second Floor Seismic Wall Map	A2	1-200
29	S-15	Structure – Third Floor Plan	A2	1-200
30	S-16	Structure – Third Floor Seismic Wall Map	A2	1-200
31	S-17	Structure – Roof Plan 01	A2	1-200
32	S-18	Structure – Roof Plan 02	A2	1-200
33	S-19	Structure – Roof Level Diagram	A2	1-200




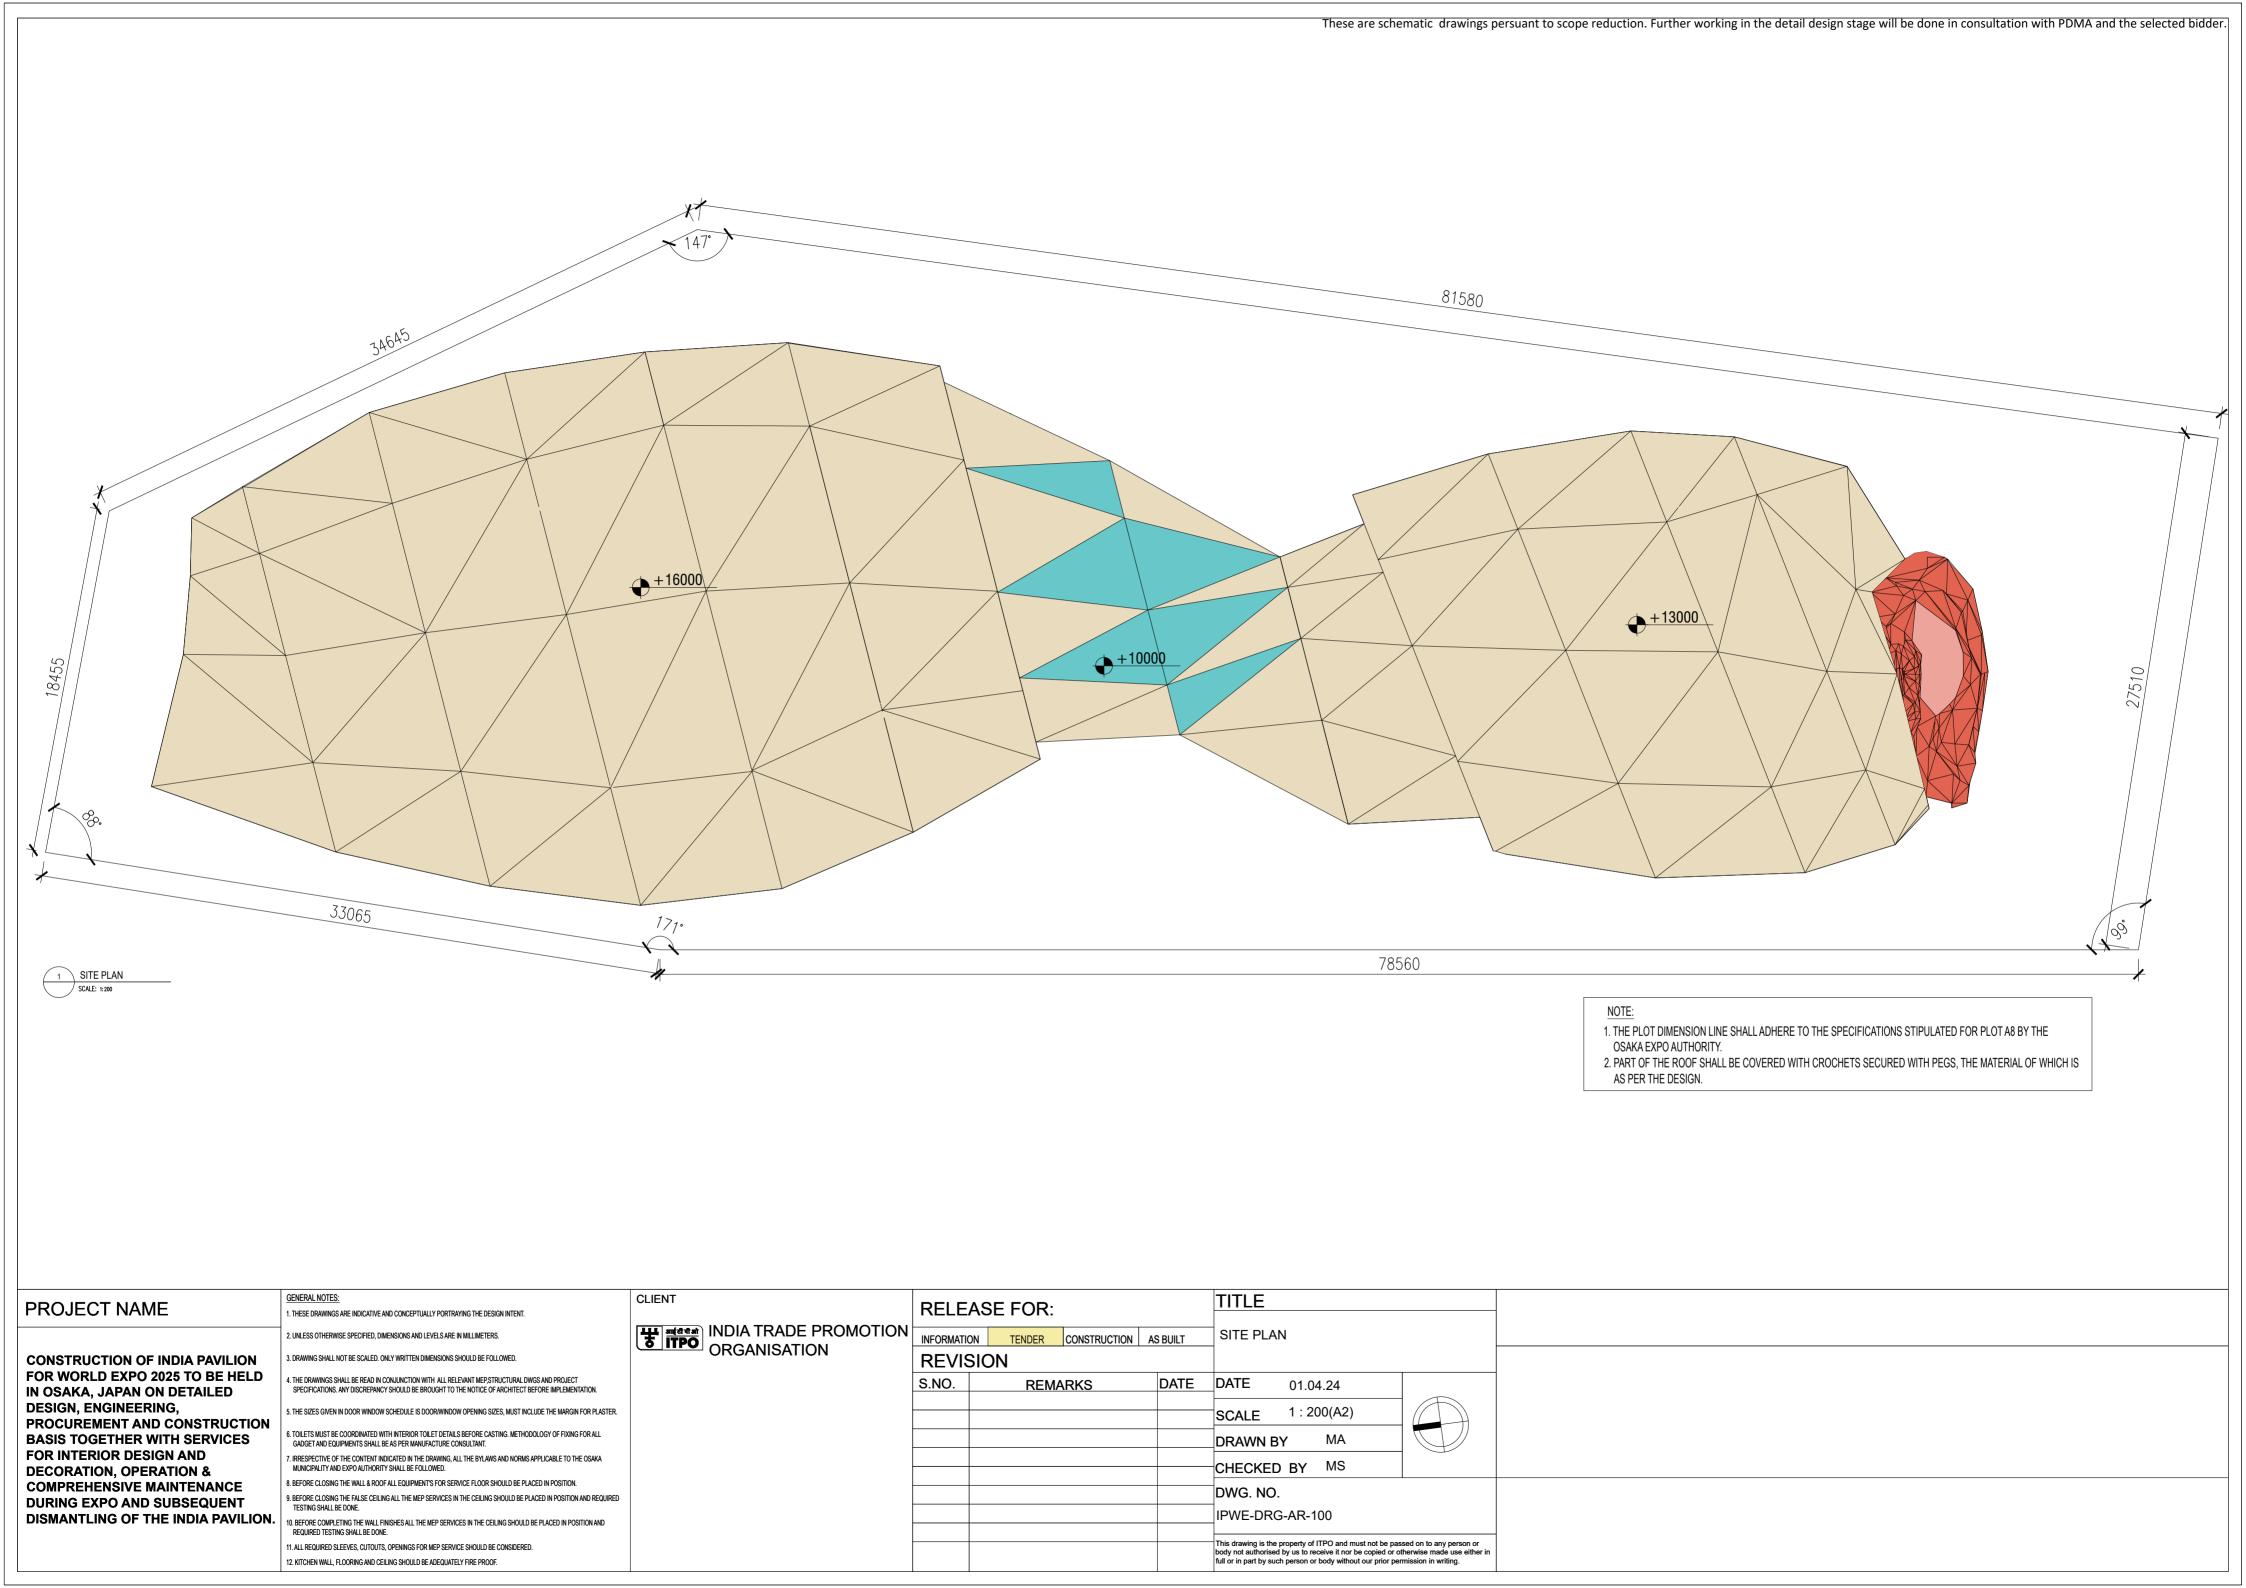


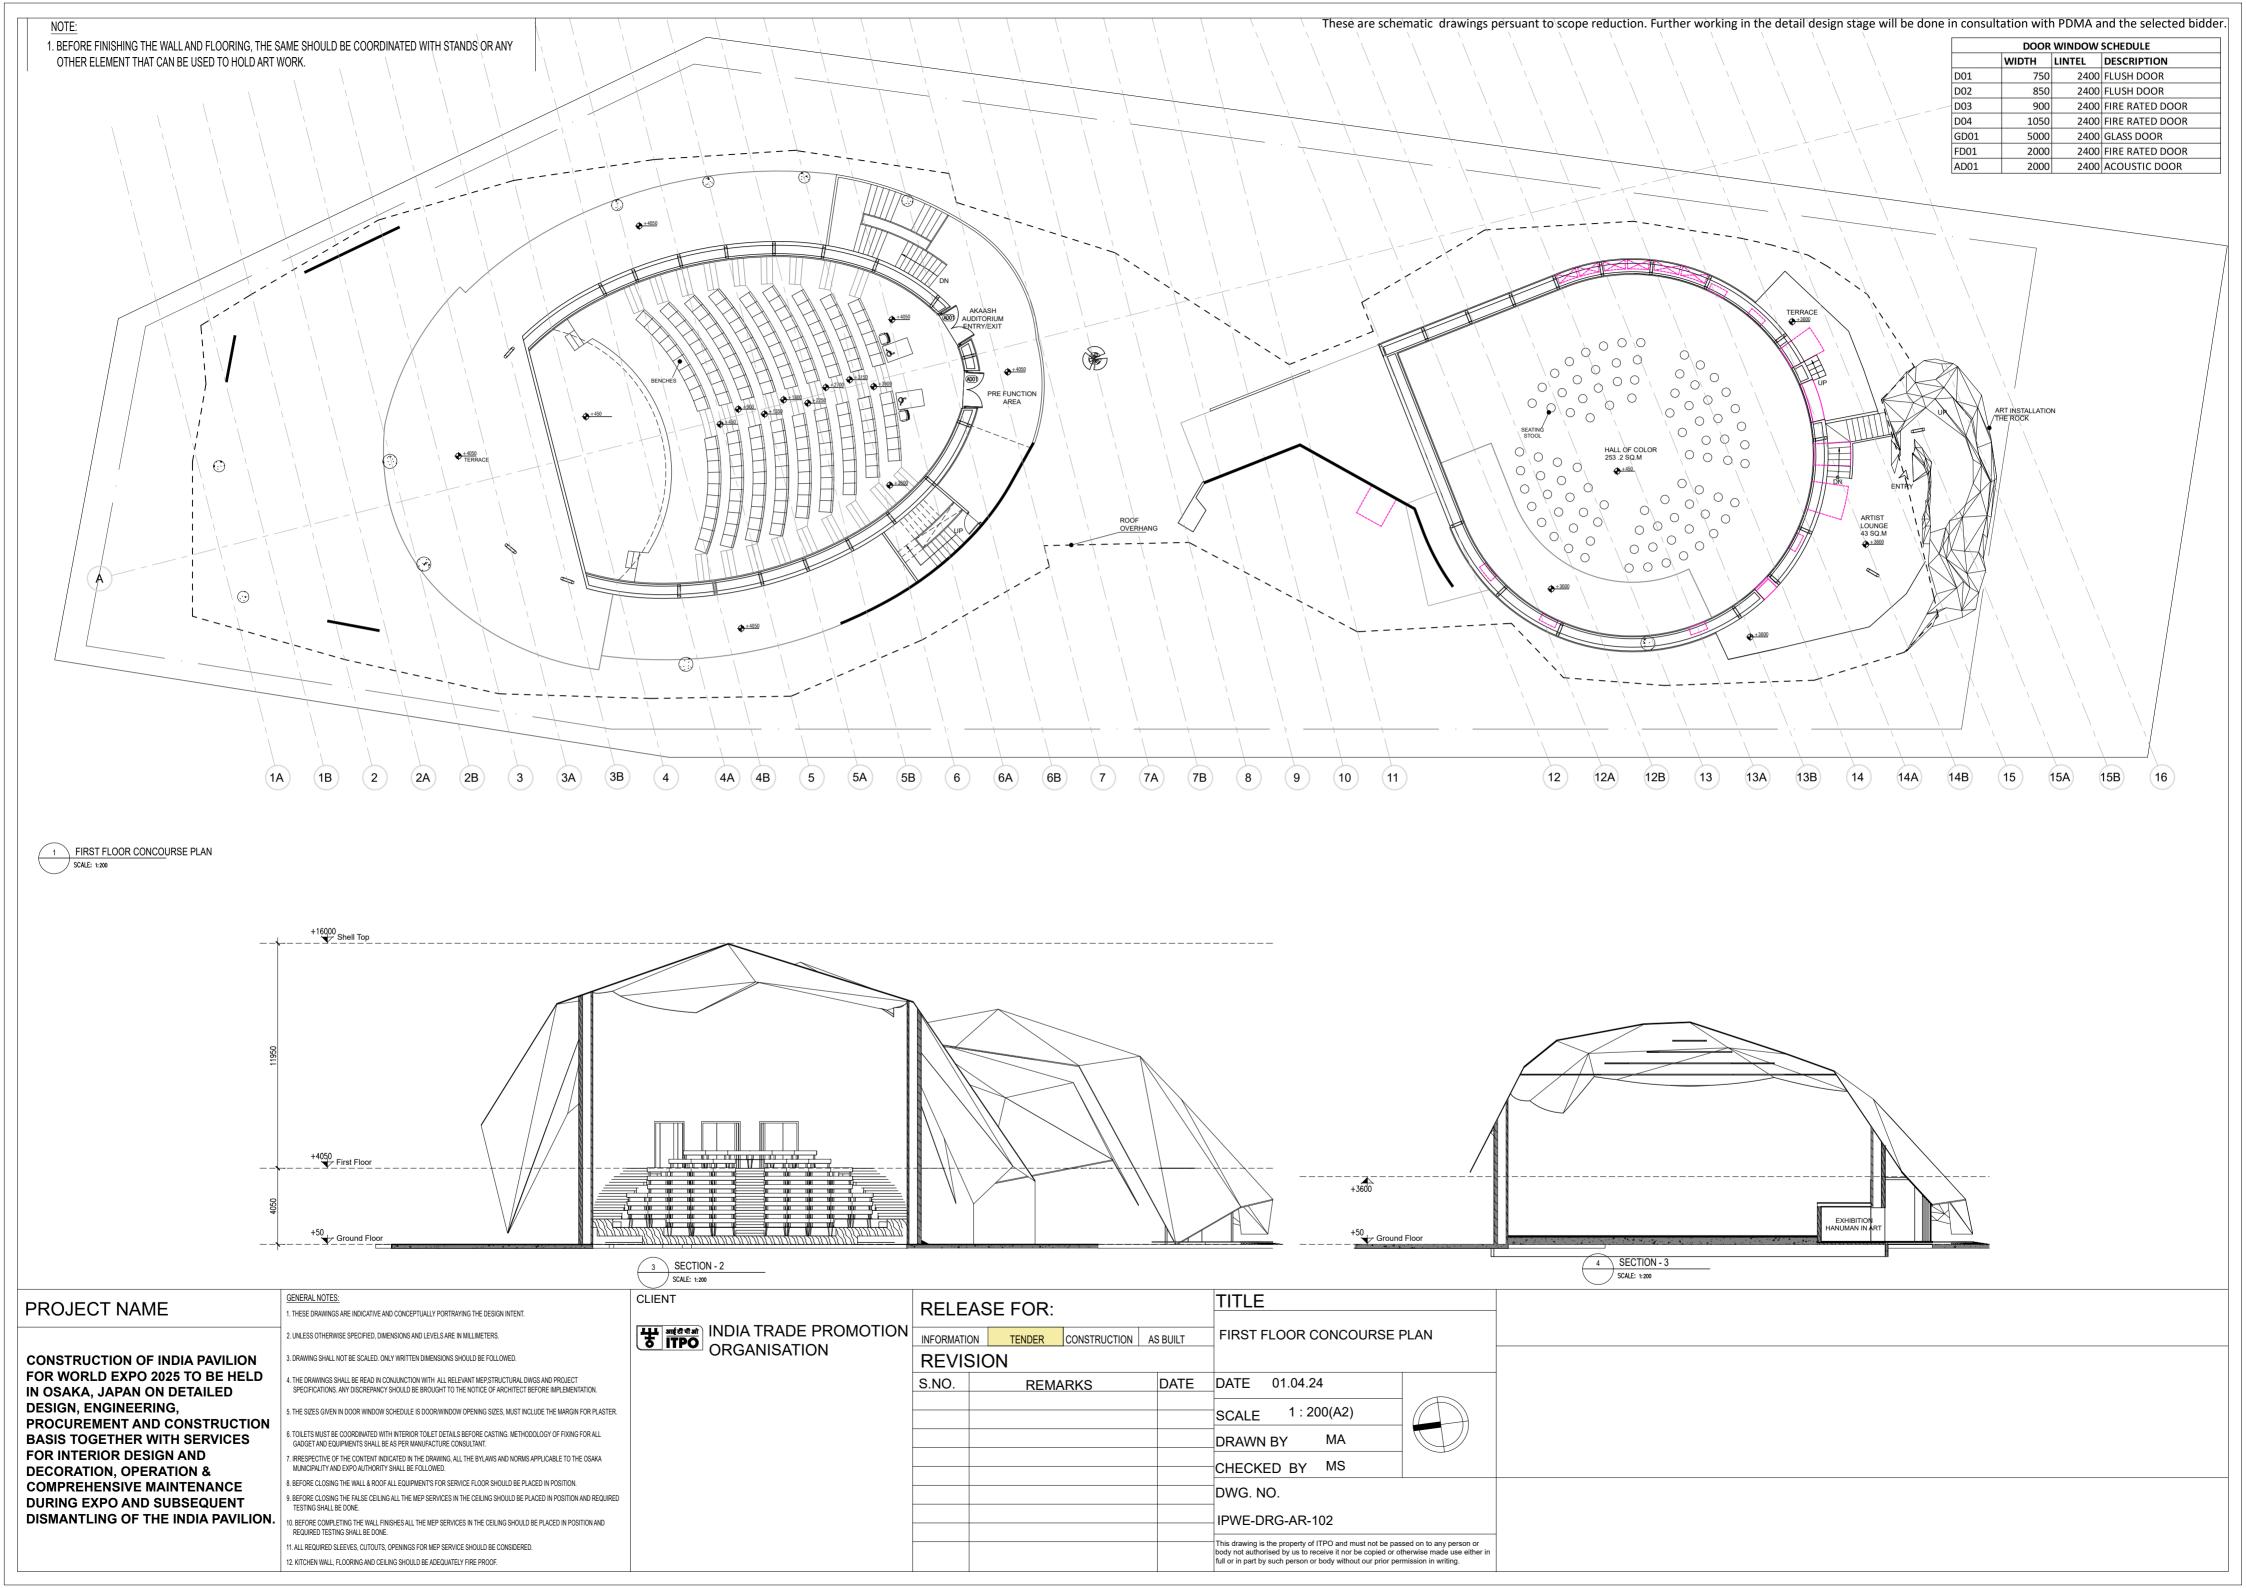

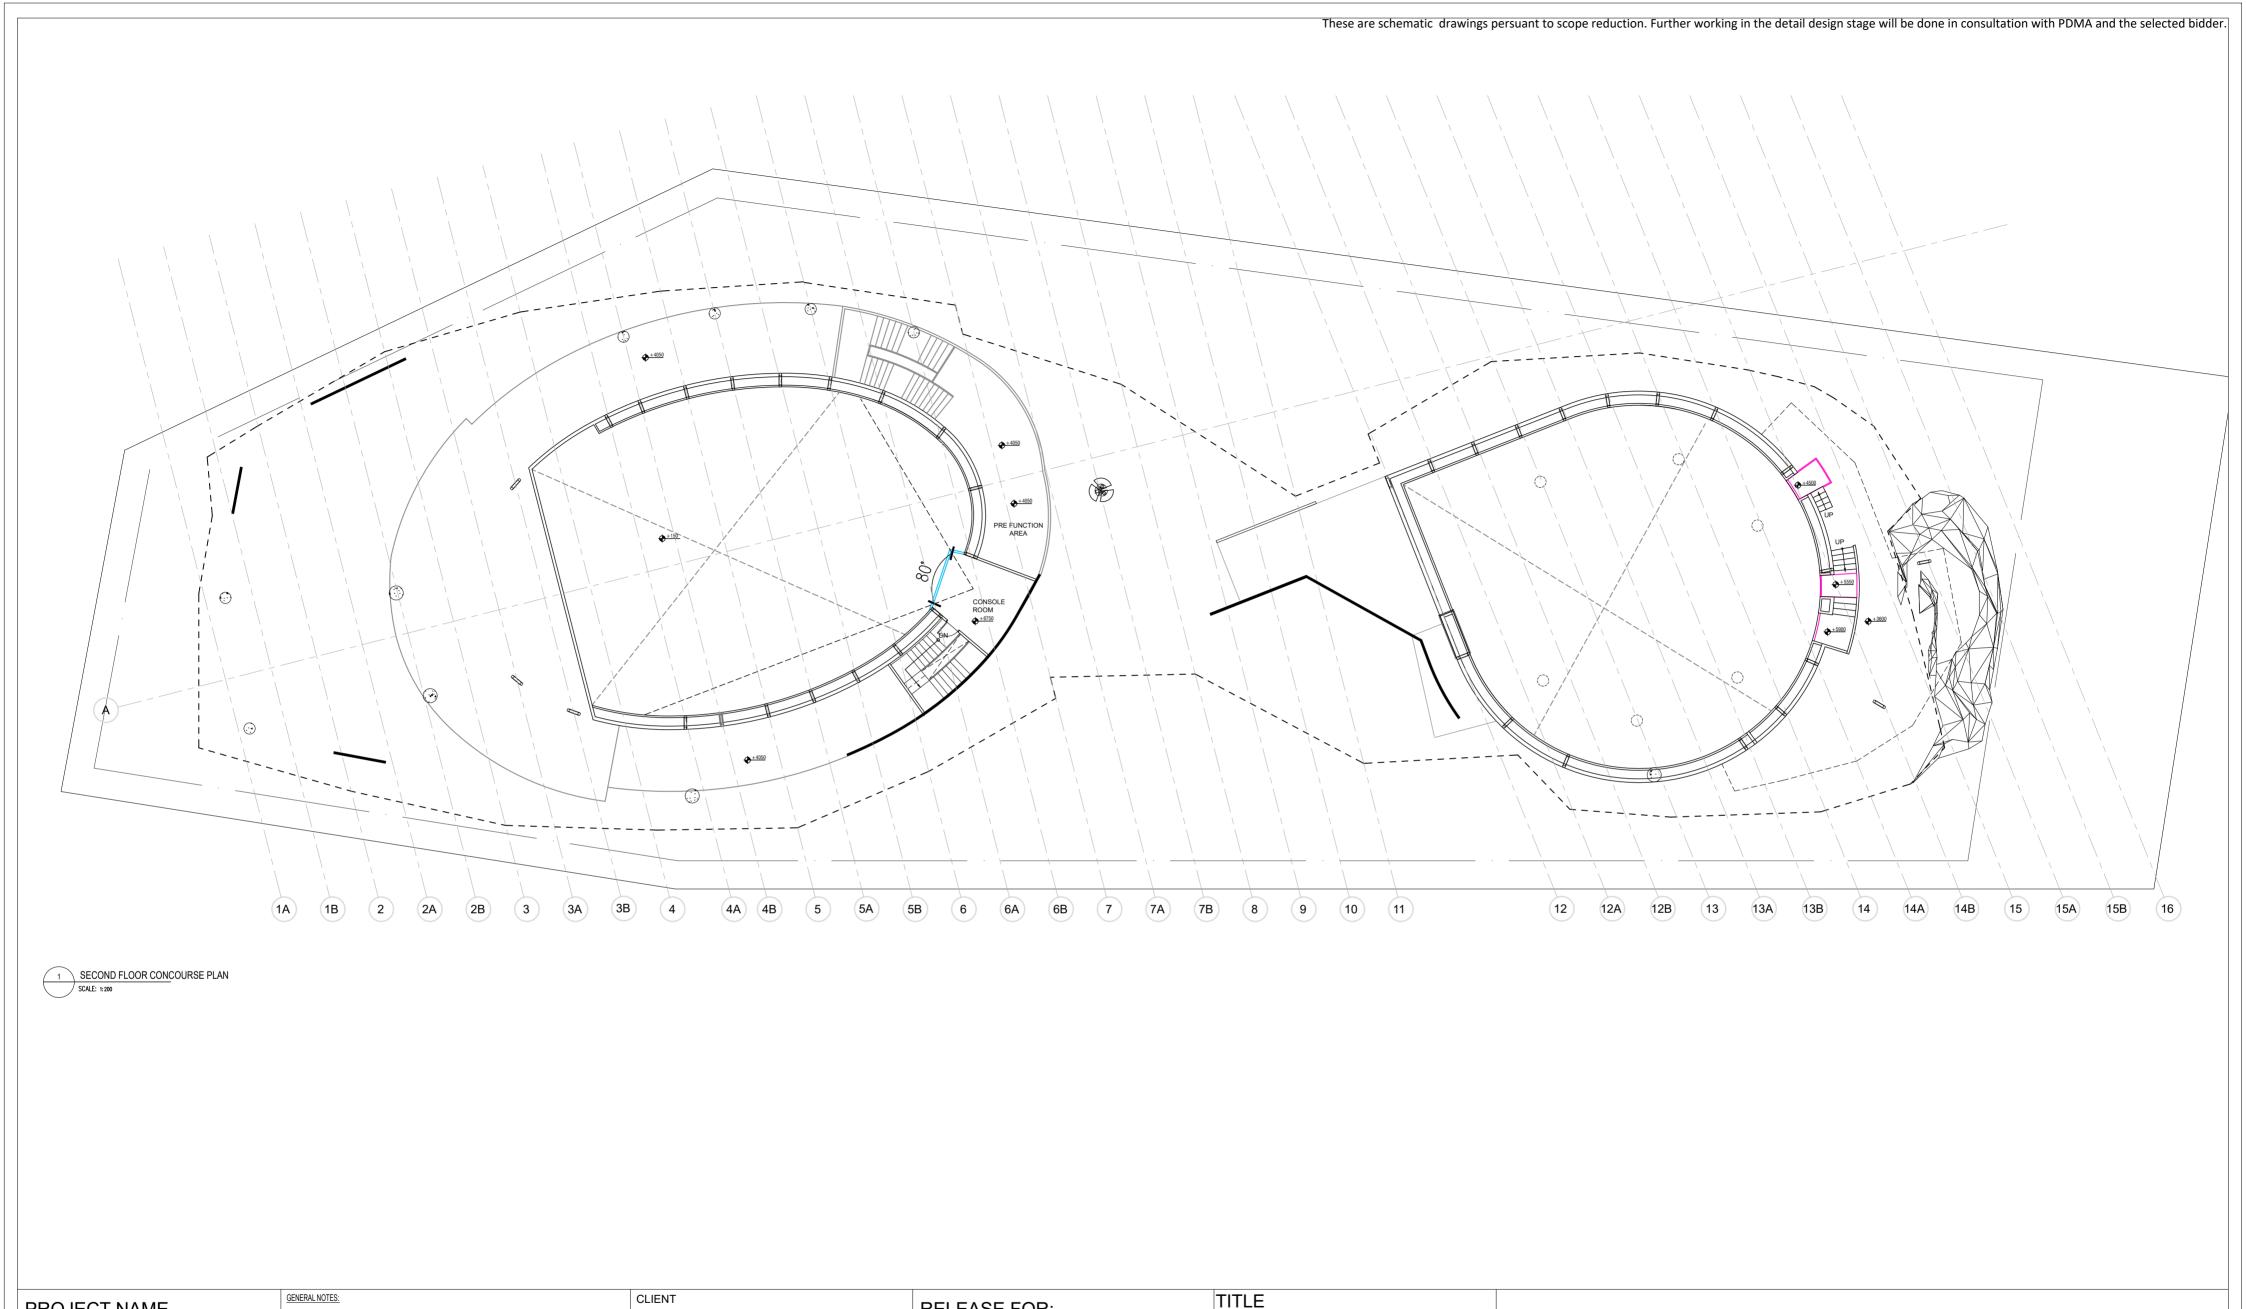


PROJECT NAME RELEASE FOR: 1. THESE DRAWINGS ARE INDICATIVE AND CONCEPTUALLY PORTRAYING THE DESIGN INTENT. **'इंग्लि** INDIA TRADE PROMOTION ORGANISATION SECOND FLOOR CONCOURSE PLAN INFORMATION TENDER CONSTRUCTION AS BUILT $2. \ {\tt UNLESS\ OTHERWISE\ SPECIFIED,\ DIMENSIONS\ AND\ LEVELS\ ARE\ IN\ MILLIMETERS.}$ 3. DRAWING SHALL NOT BE SCALED. ONLY WRITTEN DIMENSIONS SHOULD BE FOLLOWED. REVISION CONSTRUCTION OF INDIA PAVILION FOR WORLD EXPO 2025 TO BE HELD THE DRAWINGS SHALL BE READ IN CONJUNCTION WITH ALL RELEVANT MEP,STRUCTURAL DWGS AND PROJECT SPECIFICATIONS. ANY DISCREPANCY SHOULD BE BROUGHT TO THE NOTICE OF ARCHITECT BEFORE IMPLEMENTATION. S.NO. DATE DATE 01.04.24 REMARKS IN OSAKA, JAPAN ON DETAILED DESIGN, ENGINEERING, 5. THE SIZES GIVEN IN DOOR WINDOW SCHEDULE IS DOORWINDOW OPENING SIZES, MUST INCLUDE THE MARGIN FOR PLASTER. SCALE 1:200(A2) PROCUREMENT AND CONSTRUCTION 6. TOILETS MUST BE COORDINATED WITH INTERIOR TOILET DETAILS BEFORE CASTING. METHODOLOGY OF FIXING FOR ALL BASIS TOGETHER WITH SERVICES DRAWN BY MA GADGET AND EQUIPMENTS SHALL BE AS PER MANUFACTURE CONSULTANT. FOR INTERIOR DESIGN AND IRRESPECTIVE OF THE CONTENT INDICATED IN THE DRAWING, ALL THE BYLAWS AND NORMS APPLICABLE TO THE OSAKA MUNICIPALITY AND EXPO AUTHORITY SHALL BE FOLLOWED. CHECKED BY MS **DECORATION, OPERATION &** 8. BEFORE CLOSING THE WALL & ROOF ALL EQUIPMENT'S FOR SERVICE FLOOR SHOULD BE PLACED IN POSITION. COMPREHENSIVE MAINTENANCE DWG. NO. 9. BEFORE CLOSING THE FALSE CEILING ALL THE MEP SERVICES IN THE CEILING SHOULD BE PLACED IN POSITION AND REQUIRED **DURING EXPO AND SUBSEQUENT** IPWE-DRG-AR-103 DISMANTLING OF THE INDIA PAVILION. 10. BEFORE COMPLETING THE WALL FINISHES ALL THE MEP SERVICES IN THE CEILING SHOULD BE PLACED IN POSITION AND REQUIRED TESTING SHALL BE DONE. This drawing is the property of ITPO and must not be passed on to any person or body not authorised by us to receive it nor be copied or otherwise made use either i full or in part by such person or body without our prior permission in writing. ${\tt 11.ALL\,REQUIRED\,SLEEVES, CUTOUTS, OPENINGS\,FOR\,MEP\,SERVICE\,SHOULD\,BE\,CONSIDERED.}\\$ 12. KITCHEN WALL, FLOORING AND CEILING SHOULD BE ADEQUATELY FIRE PROOF.

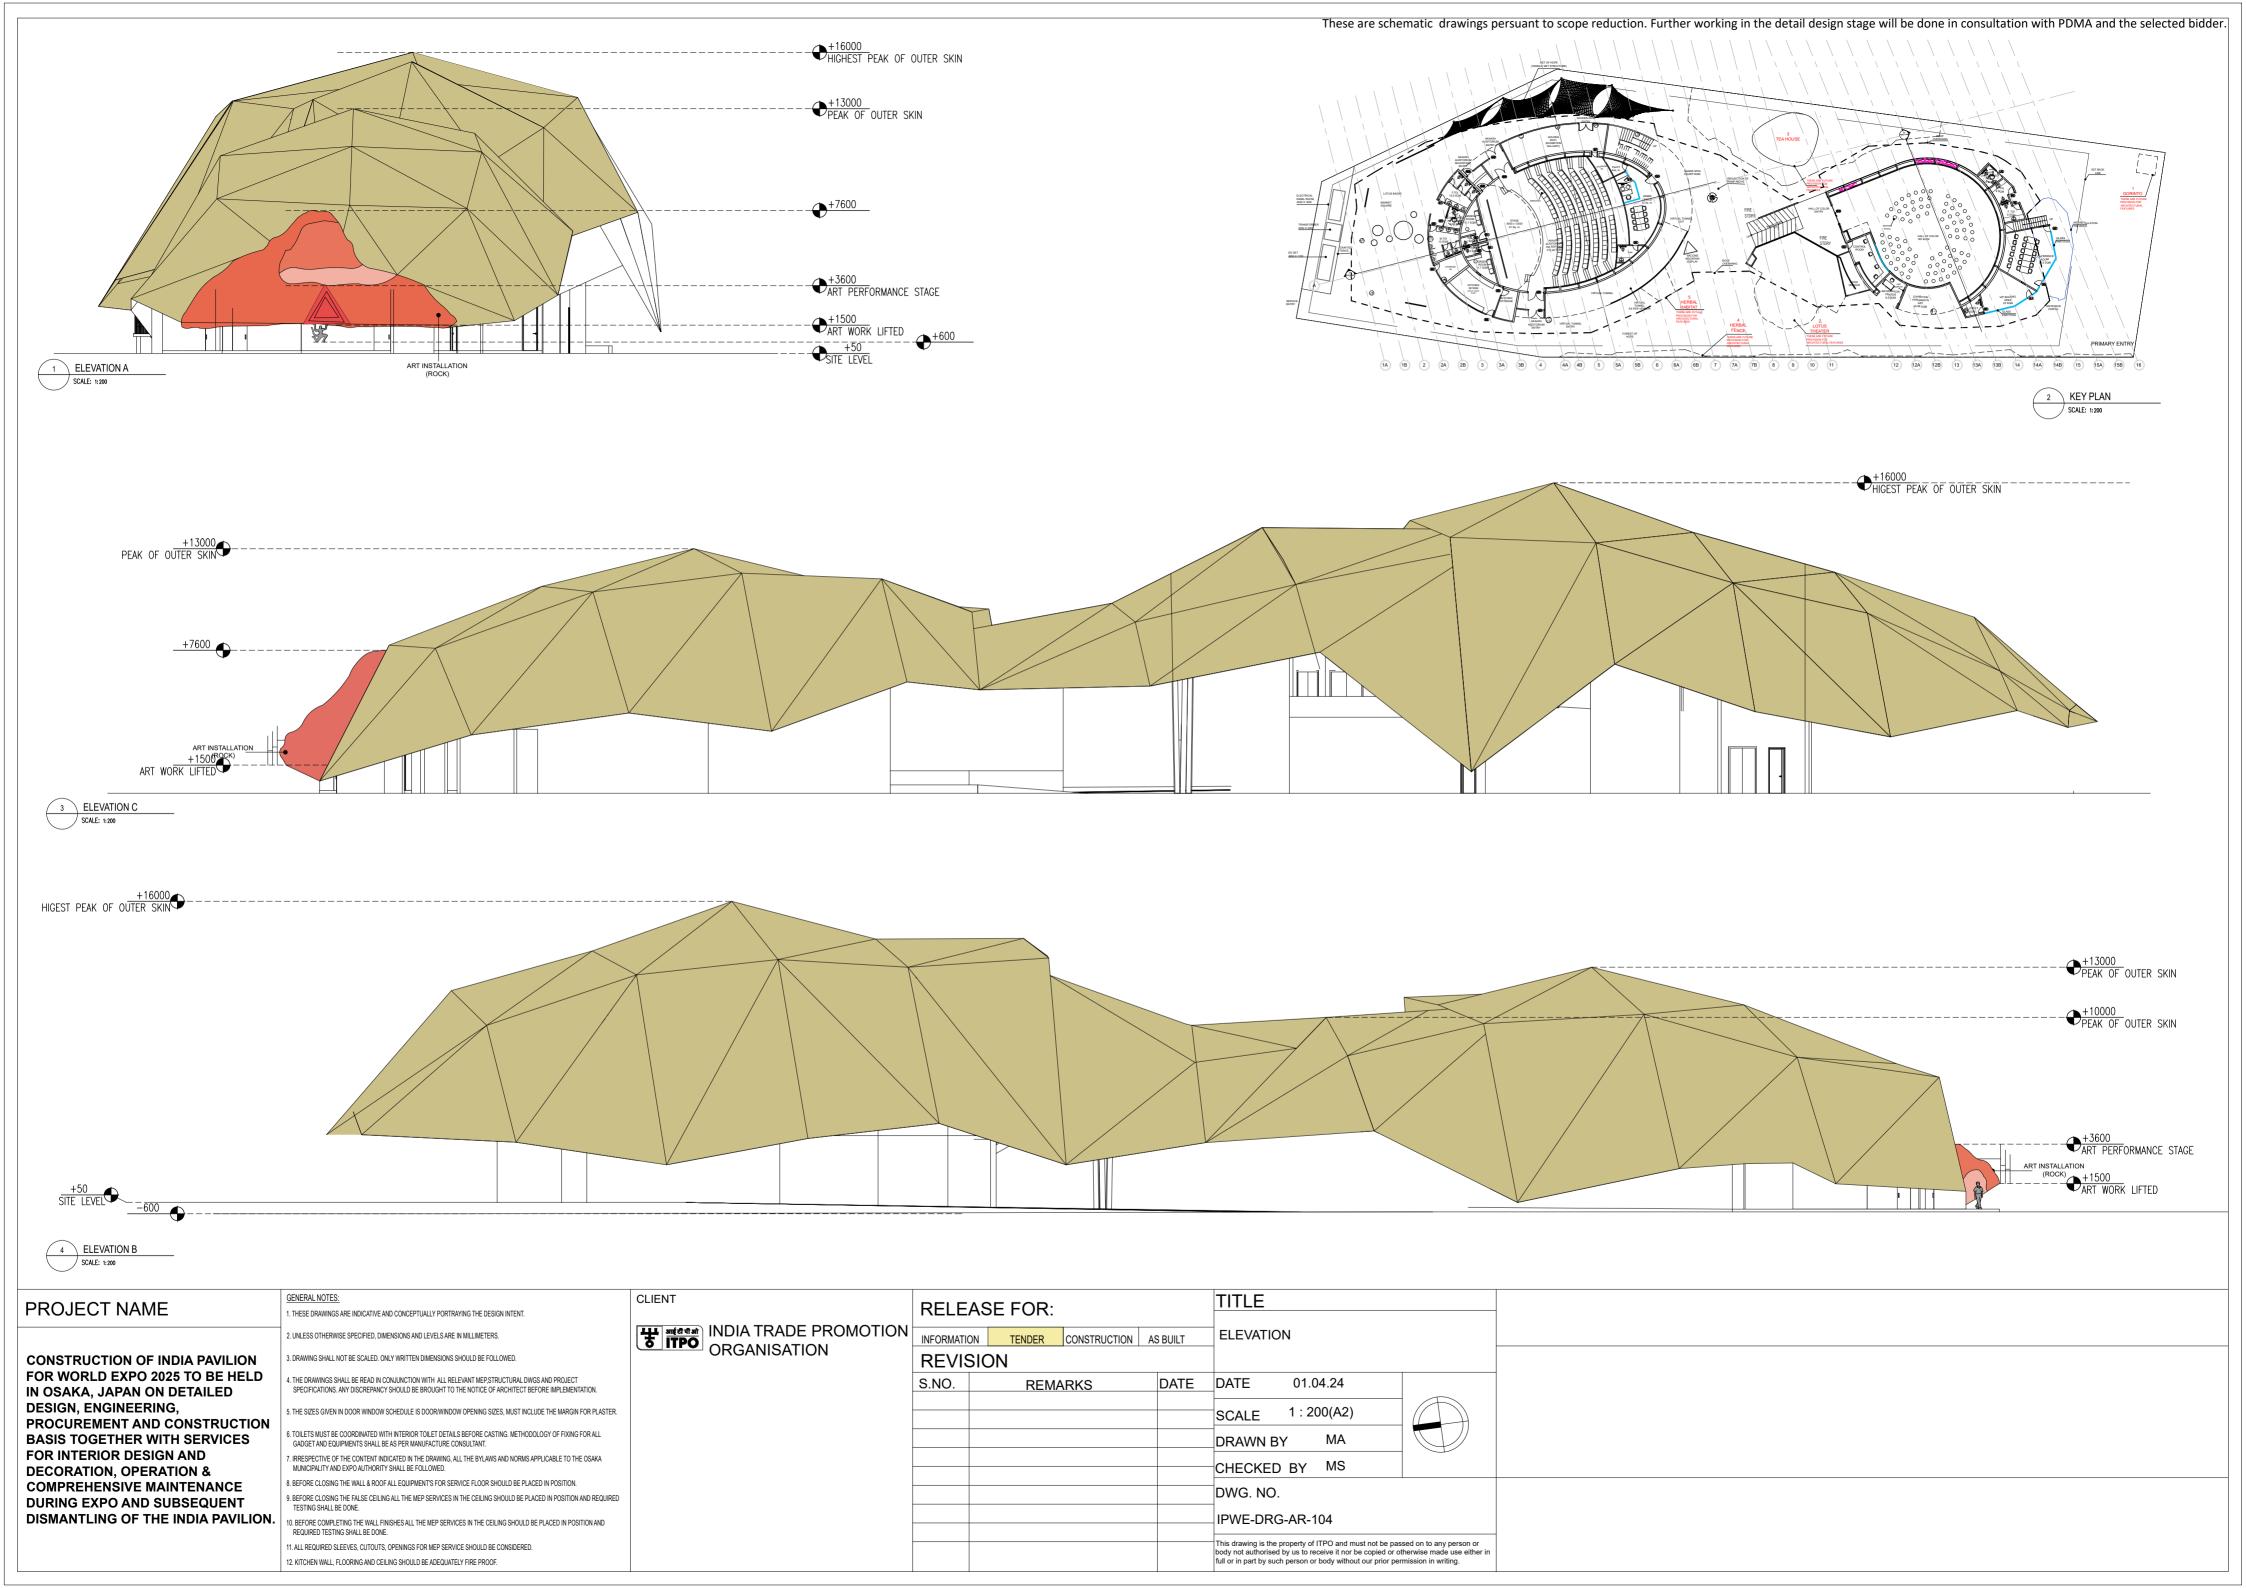

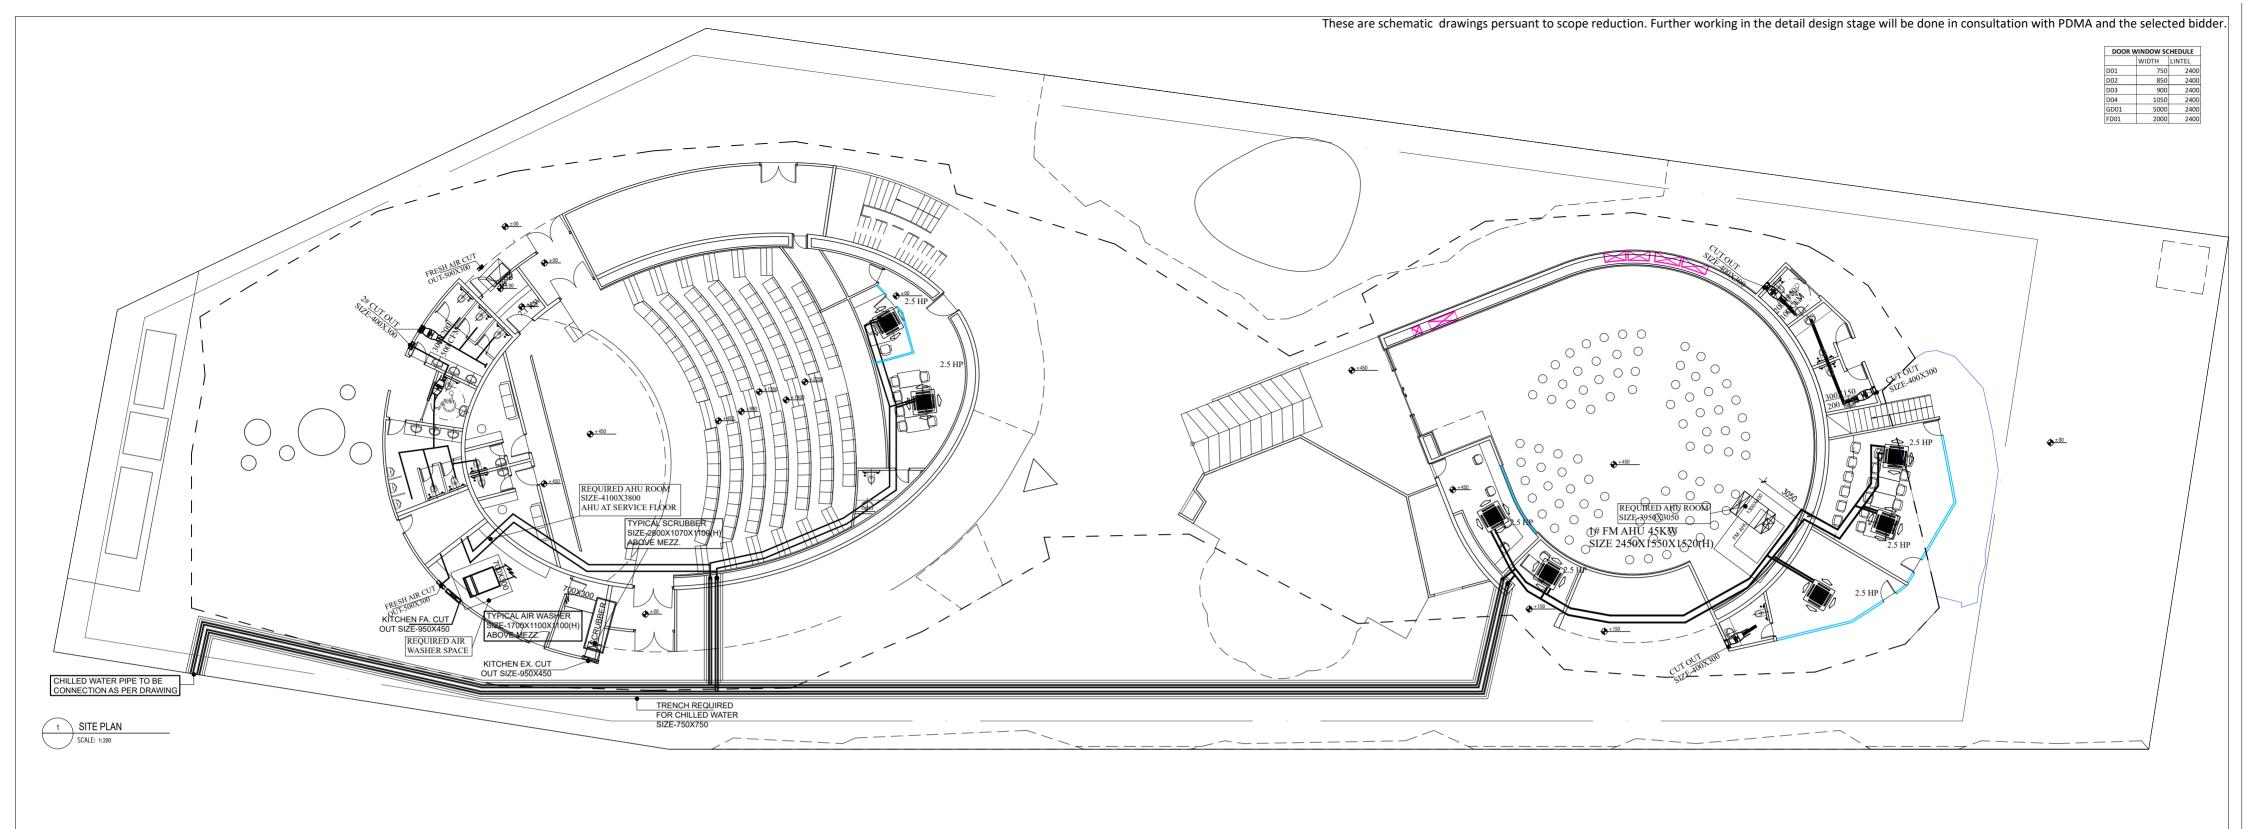


		HVAC LEGEND
01		FAN COIL UNIT
02		HEAT PUMP
03	File Andre	FM-AHU UNIT
04	Ħ	CHILED WATER PIPE
05		IN-LINE FAN
06	4	AXIAL FLOW FAN
07	4 4	SUPPLY AIR DUCT
08	44	EXHAUST AIR DUCT
09		M.F.D

PROJECT NAME	GENERAL NOTES: 1. THESE DRAWINGS ARE INDICATIVE AND CONCEPTUALLY PORTRAYING THE DESIGN INTENT.	CLIENT	RELEASE FOR:		TITLE
	2. UNLESS OTHERWISE SPECIFIED, DIMENSIONS AND LEVELS ARE IN MILLIMETERS.	INDIA TRADE PROMOTION ORGANISATION	INFORMATION TENDER CONSTRUCTION AS	BUILT	GROUND FLOOR HVAC LAYOUT
CONSTRUCTION OF INDIA PAVILION	3. DRAWING SHALL NOT BE SCALED. ONLY WRITTEN DIMENSIONS SHOULD BE FOLLOWED.	ONGANISATION	REVISION		
FOR WORLD EXPO 2025 TO BE HELD IN OSAKA, JAPAN ON DETAILED	4. THE DRAWINGS SHALL BE READ IN CONJUNCTION WITH ALL RELEVANT MEP.STRUCTURAL DWGS AND PROJECT SPECIFICATIONS. ANY DISCREPANCY SHOULD BE BROUGHT TO THE NOTICE OF ARCHITECT BEFORE IMPLEMENTATION.		S.NO. REMARKS	DATE	DATE 01.04.24
DESIGN, ENGINEERING, PROCUREMENT AND CONSTRUCTION	5. THE SIZES GIVEN IN DOOR WINDOW SCHEDULE IS DOOR/WINDOW OPENING SIZES, MUST INCLUDE THE MARGIN FOR PLASTER.				SCALE 1:200 (A2)
BASIS TOGETHER WITH SERVICES	6. TOILETS MUST BE COORDINATED WITH INTERIOR TOILET DETAILS BEFORE CASTING. METHODOLOGY OF FIXING FOR ALL GADGET AND EQUIPMENTS SHALL BE AS PER MANUFACTURE CONSULTANT.				DRAWN BY I.A.
FOR INTERIOR DESIGN AND DECORATION, OPERATION &	7. IRRESPECTIVE OF THE CONTENT INDICATED IN THE DRAWING, ALL THE BYLAWS AND NORMS APPLICABLE TO THE OSAKA MUNICIPALITY AND EXPO AUTHORITY SHALL BE FOLLOWED.				CHECKED BY I.A.
COMPREHENSIVE MAINTENANCE	8. BEFORE CLOSING THE WALL & ROOF ALL EQUIPMENT'S FOR SERVICE FLOOR SHOULD BE PLACED IN POSITION.				DWG. NO.
DURING EXPO AND SUBSEQUENT	 BEFORE CLOSING THE FALSE CEILING ALL THE MEP SERVICES IN THE CEILING SHOULD BE PLACED IN POSITION AND REQUIRED TESTING SHALL BE DONE. 				
DISMANTLING OF THE INDIA PAVILION.	10. BEFORE COMPLETING THE WALL FINISHES ALL THE MEP SERVICES IN THE CEILING SHOULD BE PLACED IN POSITION AND REQUIRED TESTING SHALL BE DONE.				IPWE-DRG-HVAC-101R
	11. ALL REQUIRED SLEEVES, CUTOUTS, OPENINGS FOR MEP SERVICE SHOULD BE CONSIDERED.				This drawing is the property of ITPO and must not be passed on to any person or body not authorised by us to receive it nor be copied or otherwise made use either in
	12. KITCHEN WALL, FLOORING AND CEILING SHOULD BE ADEQUATELY FIRE PROOF.				full or in part by such person or body without our prior permission in writing.

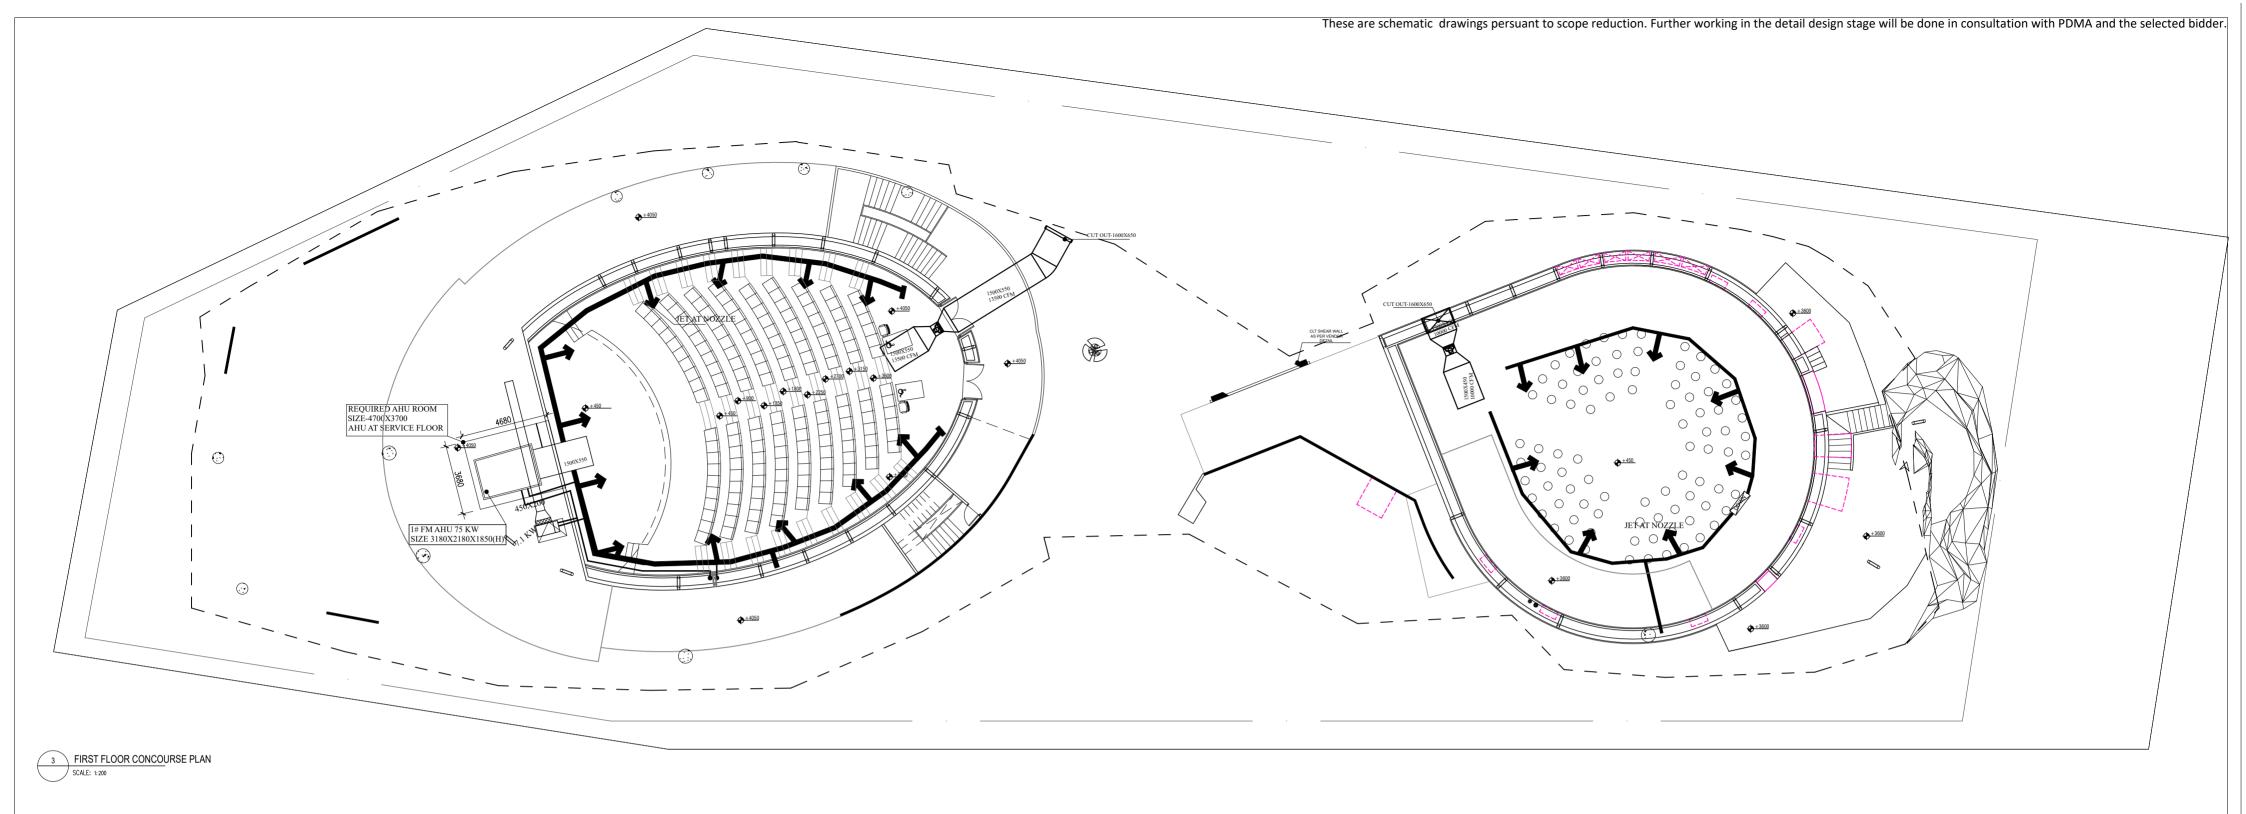

		HVAC LEGEND
01		FAN COIL UNIT
02		HEAT PUMP
03	Fil. AND	FM-AHU UNIT
04	Ħ	CHILED WATER PIPE
05		IN-LINE FAN
06	4	AXIAL FLOW FAN
07	4	SUPPLY AIR DUCT
08	4 4	EXHAUST AIR DUCT
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CONSTRUCTION OF INDIA PAVILION	3. DRAWING SHALL NOT BE SCALED. ONLY WRITTEN DIMENSIONS SHOULD BE FOLLOWED.	ONGANISATION	REVISIO	N		
FOR WORLD EXPO 2025 TO BE HELD IN OSAKA, JAPAN ON DETAILED	4. THE DRAWINGS SHALL BE READ IN CONJUNCTION WITH ALL RELEVANT MEP, STRUCTURAL DWGS AND PROJECT SPECIFICATIONS. ANY DISCREPANCY SHOULD BE BROUGHT TO THE NOTICE OF ARCHITECT BEFORE IMPLEMENTATION.		S.NO.	REMARKS	DATE	E DATE 01.04.24
DESIGN, ENGINEERING, PROCUREMENT AND CONSTRUCTION	5. THE SIZES GIVEN IN DOOR WINDOW SCHEDULE IS DOORWINDOW OPENING SIZES, MUST INCLUDE THE MARGIN FOR PLASTER.					SCALE 1: 200 (A2)
BASIS TOGETHER WITH SERVICES	 TOILETS MUST BE COORDINATED WITH INTERIOR TOILET DETAILS BEFORE CASTING. METHODOLOGY OF FIXING FOR ALL GADGET AND EQUIPMENTS SHALL BE AS PER MANUFACTURE CONSULTANT. 					DRAWN BY I.A.
FOR INTERIOR DESIGN AND DECORATION, OPERATION &	7. IRRESPECTIVE OF THE CONTENT INDICATED IN THE DRAWING, ALL THE BYLAWS AND NORMS APPLICABLE TO THE OSAKA MUNICIPALITY AND EXPO AUTHORITY SHALL BE FOLLOWED.					CHECKED BY I.A.
COMPREHENSIVE MAINTENANCE	8. BEFORE CLOSING THE WALL & ROOF ALL EQUIPMENT'S FOR SERVICE FLOOR SHOULD BE PLACED IN POSITION.					DWG. NO.
DURING EXPO AND SUBSEQUENT	9. BEFORE CLOSING THE FALSE CEILING ALL THE MEP SERVICES IN THE CEILING SHOULD BE PLACED IN POSITION AND REQUIRED TESTING SHALL BE DONE.					BWG. NO.
DISMANTLING OF THE INDIA PAVILION.	10. BEFORE COMPLETING THE WALL FINISHES ALL THE MEP SERVICES IN THE CEILING SHOULD BE PLACED IN POSITION AND REQUIRED TESTING SHALL BE DONE.					IPWE-DRG-HVAC-102R
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LEGEND:-	DESCRIPTION	MT.HEIGHT(MM) FROM FFL
<u>É</u>	ONE WAY SWITCH BOARD (EMERGENCY CONTROL)	1200 MM
<u>6</u>	ONE WAY SWITCH BOARD	1200 MM
igorplus	10W LED SURFACE DOWNLIGHTER	ON CEILING
\mathbf{Q}	10W LED SURFACE DOWNLIGHTER (EMERGENCY CONTROL)	ON CEILING
	15W LED SURFACE DOWNLIGHTER	ON CEILING
	15W LED SURFACE DOWNLIGHTER (EMERGENCY CONTROL)	ON CEILING
	18W LED SURFACE DOWNLIGHTER	ON CEILING
≥ E	18W LED SURFACE DOWNLIGHTER (EMERGENCY CONTROL)	ON CEILING
-	10W LED RECESS DOWNLIGHTER	ON FALSE CEILING
- ∳ Ē	10W LED RECESS DOWNLIGHTER (EMERGENCY CONTROL)	ON FALSE CEILING
\oplus	15W LED RECESS DOWNLIGHTER	ON FALSE CEILING
	15W LED RECESS DOWNLIGHTER (EMERGENCY CONTROL)	ON FALSE CEILING
+	18W LED RECESS DOWNLIGHTER	ON FALSE CEILING
+ E	18W LED RECESS DOWNLIGHTER (EMERGENCY CONTROL)	ON FALSE CEILING
₩	10W LED WALL MOUNTED LIGHT (IP-20)	AS PER DETAIL
- и	20W LED CEILING MOUNTED LIGHT	ON CEILING
ш	20W LED CEILING MOUNTED LIGHT (EMERGENCY CONTROL)	ON CEILING
	40W LED CEILING MOUNTED LIGHT	ON CEILING
	STEP LIGHT	600 MM

CONSTRUCTION OF INDIA PAVILION FOR WORLD EXPO 2025 TO BE HELD IN OSAKA, JAPAN ON DETAILED DESIGN, ENGINEERING, PROCUREMENT AND CONSTRUCTION BASIS TOGETHER WITH SERVICES FOR INTERIOR DESIGN AND **DECORATION, OPERATION &** COMPREHENSIVE MAINTENANCE **DURING EXPO AND SUBSEQUENT** DISMANTLING OF THE INDIA PAVILION.

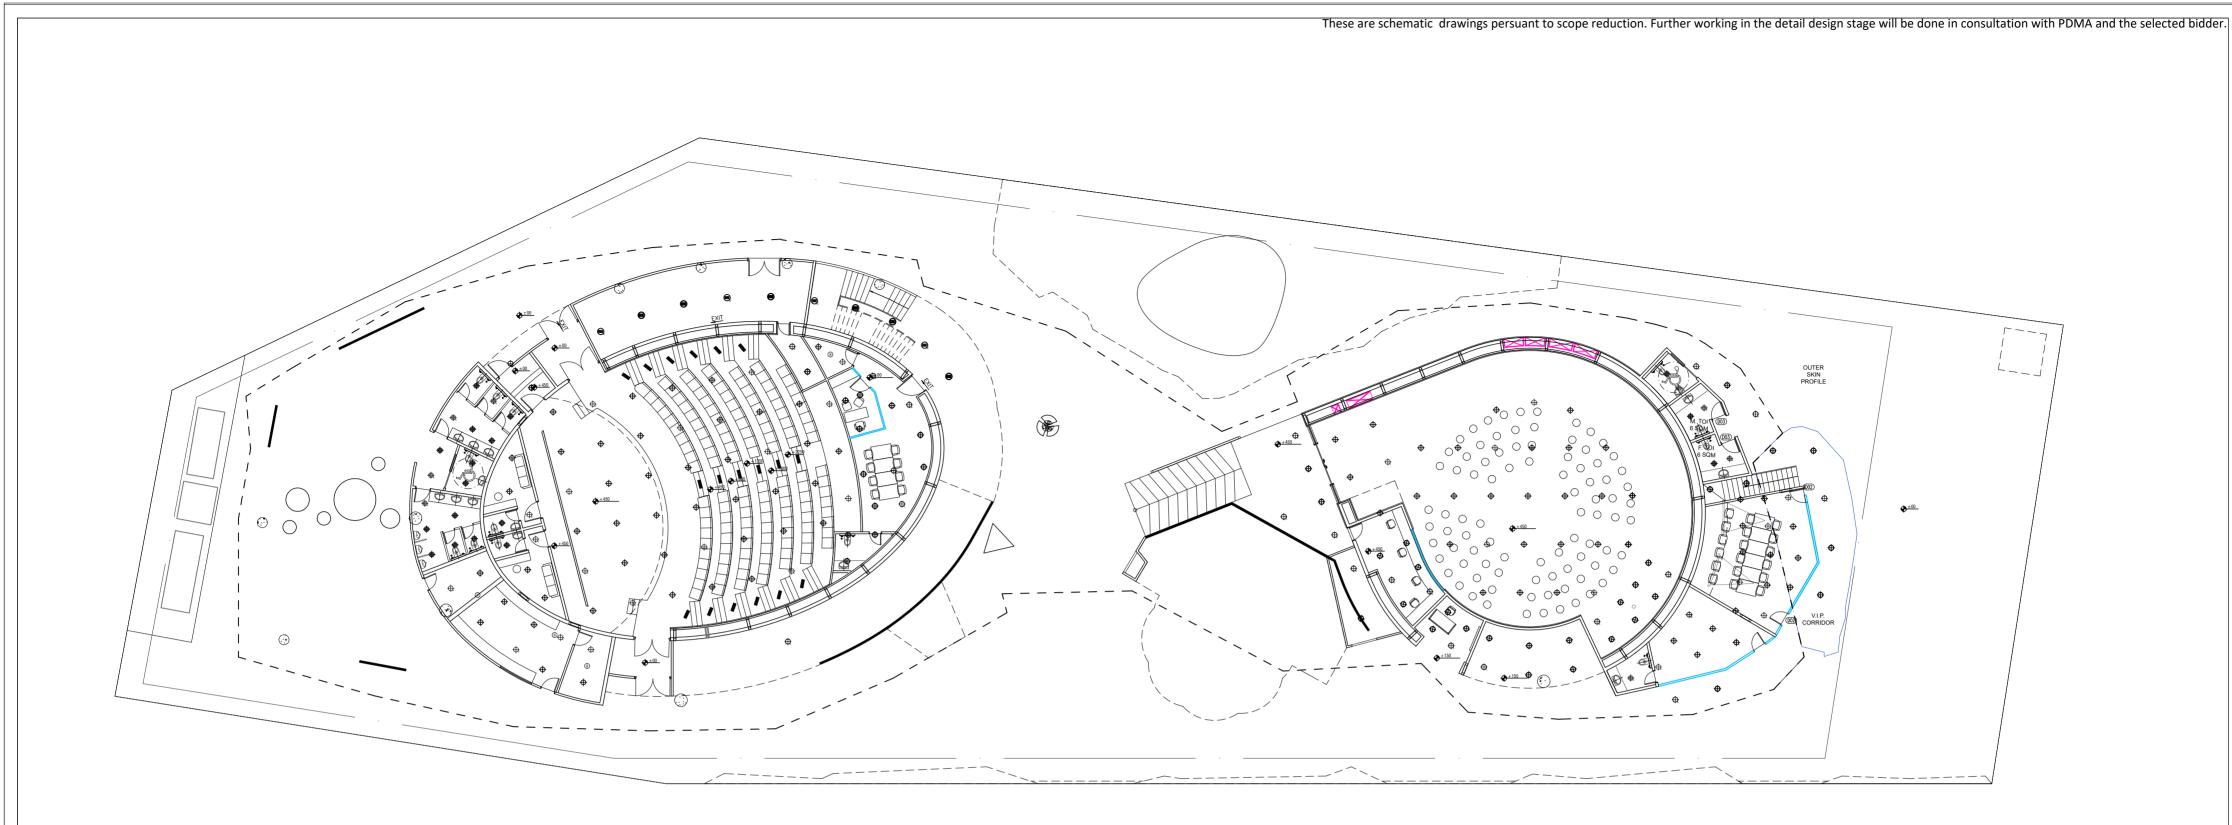GENERAL NOTES:

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5. THE SIZES GIVEN IN DOOR WINDOW SCHEDULE IS DOORWINDOW OPENING SIZES, MUST INCLUDE THE MARGIN FOR PLASTER.

6. TOILETS MUST BE COORDINATED WITH INTERIOR TOILET DETAILS BEFORE CASTING. METHODOLOGY OF FIXING FOR ALL

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9. BEFORE CLOSING THE FALSE CEILING ALL THE MEP SERVICES IN THE CEILING SHOULD BE PLACED IN POSITION AND REQUIRED

10. BEFORE COMPLETING THE WALL FINISHES ALL THE MEP SERVICES IN THE CEILING SHOULD BE PLACED IN POSITION AND REQUIRED TESTING SHALL BE DONE.


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CLIENT

 'इंग्लि INDIA TRADE PROMOTION ORGANISATION

	RELEASE FOR:				TITLE			
1	INFORMATIO		TENDER	CONSTRUCTION	Δ.	S BUILT	LIGHTING LAYOUT	
	REVIS			CONCINCOTION	7.0	J DOILI	GROUND FLOOR	
	S.NO.		REMA	ARKS		DATE	DATE-14.03.2024	
							SCALE-NTS	
							DRAWN BY-SUKHDEV	
							CHECKED BY SHAMBUNATH	
							DWG. NO.	
							IPWE-DRG-ELE-101R	

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LEGEND:-	DESCRIPTION	MT.HEIGHT (MM)
X	6A RAW POWER SOCKET WITH SWITCH	230 MM
Å	6/16A RAW POWER SOCKET WITH SWITCH OUTLET	230 MM
Á	6/16A RAW POWER SOCKET WITH SWITCH OUTLET FOR HAND DRAWER	AS PER DETAIL

। INDIA TRADE PROMOTION ORGANISATION **POWER LAYOUT** INFORMATION TENDER CONSTRUCTION AS BUILT $2.\,{\rm UNLESS}\,{\rm OTHERWISE}\,{\rm SPECIFIED}, {\rm DIMENSIONS}\,{\rm AND}\,{\rm LEVELS}\,{\rm ARE}\,{\rm IN}\,{\rm MILLIMETERS}.$ **GROUND FLOOR** 3. DRAWING SHALL NOT BE SCALED. ONLY WRITTEN DIMENSIONS SHOULD BE FOLLOWED. REVISION CONSTRUCTION OF INDIA PAVILION FOR WORLD EXPO 2025 TO BE HELD 4. THE DRAWINGS SHALL BE READ IN CONJUNCTION WITH ALL RELEVANT MEP.STRUCTURAL DWGS AND PROJECT SPECIFICATIONS. ANY DISCREPANCY SHOULD BE BROUGHT TO THE NOTICE OF ARCHITECT BEFORE IMPLEMENTATION. DATE DATE-14.03.2024 S.NO. REMARKS IN OSAKA, JAPAN ON DETAILED DESIGN, ENGINEERING, 5. THE SIZES GIVEN IN DOOR WINDOW SCHEDULE IS DOOR/WINDOW OPENING SIZES, MUST INCLUDE THE MARGIN FOR PLASTER. SCALE-NTS PROCUREMENT AND CONSTRUCTION 6. TOILETS MUST BE COORDINATED WITH INTERIOR TOILET DETAILS BEFORE CASTING. METHODOLOGY OF FIXING FOR ALL BASIS TOGETHER WITH SERVICES DRAWN BY-SUKHDEV GADGET AND EQUIPMENTS SHALL BE AS PER MANUFACTURE CONSULTANT. FOR INTERIOR DESIGN AND 7. IRRESPECTIVE OF THE CONTENT INDICATED IN THE DRAWING, ALL THE BYLAWS AND NORMS APPLICABLE TO THE OSAKA MUNICIPALITY AND EXPO AUTHORITY SHALL BE FOLLOWED. CHECKED BY SHAMBUNATH **DECORATION, OPERATION &** 8. BEFORE CLOSING THE WALL & ROOF ALL EQUIPMENT'S FOR SERVICE FLOOR SHOULD BE PLACED IN POSITION. COMPREHENSIVE MAINTENANCE DWG. NO. 9. BEFORE CLOSING THE FALSE CEILING ALL THE MEP SERVICES IN THE CEILING SHOULD BE PLACED IN POSITION AND REQUIRED **DURING EXPO AND SUBSEQUENT** DISMANTLING OF THE INDIA PAVILION. 10. BEFORE COMPLETING THE WALL FINISHES ALL THE MEP SERVICES IN THE CEILING SHOULD BE PLACED IN POSITION AND REQUIRED TESTING SHALL BE DONE. IPWE-DRG-ELE-102R This drawing is the property of ITPO and must not be passed on to any person or body not authorised by us to receive it nor be copied or otherwise made use either in full or in part by such person or body without our prior permission in writing. 11. ALL REQUIRED SLEEVES, CUTOUTS, OPENINGS FOR MEP SERVICE SHOULD BE CONSIDERED. 12. KITCHEN WALL, FLOORING AND CEILING SHOULD BE ADEQUATELY FIRE PROOF.

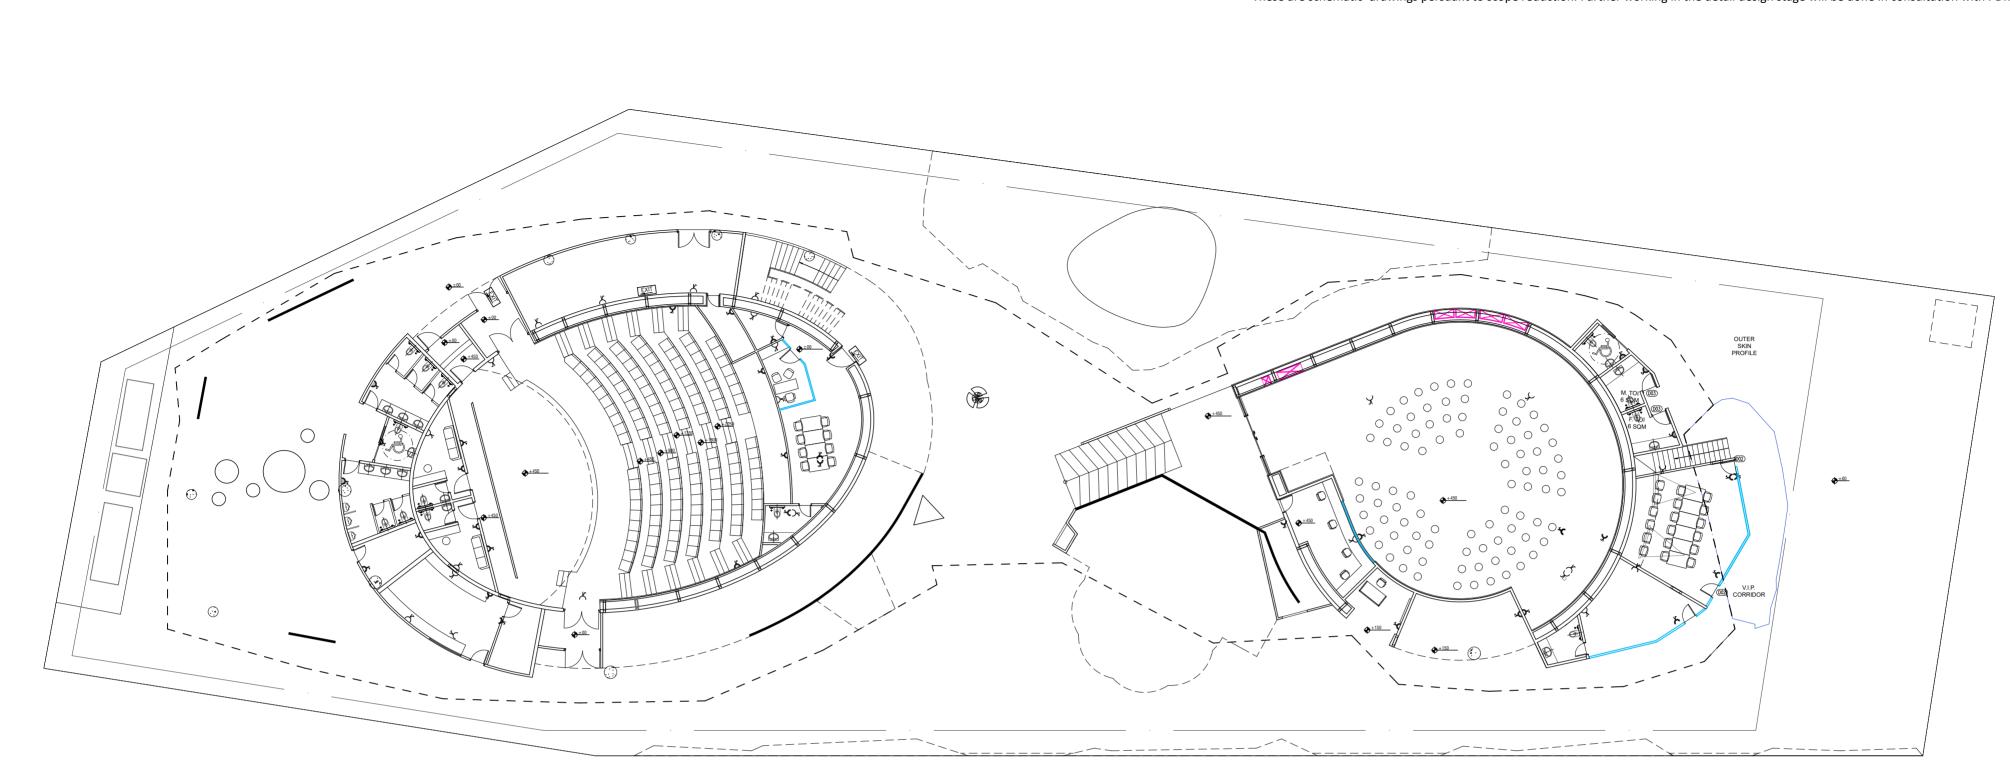RELEASE FOR:


TITLE

PROJECT NAME

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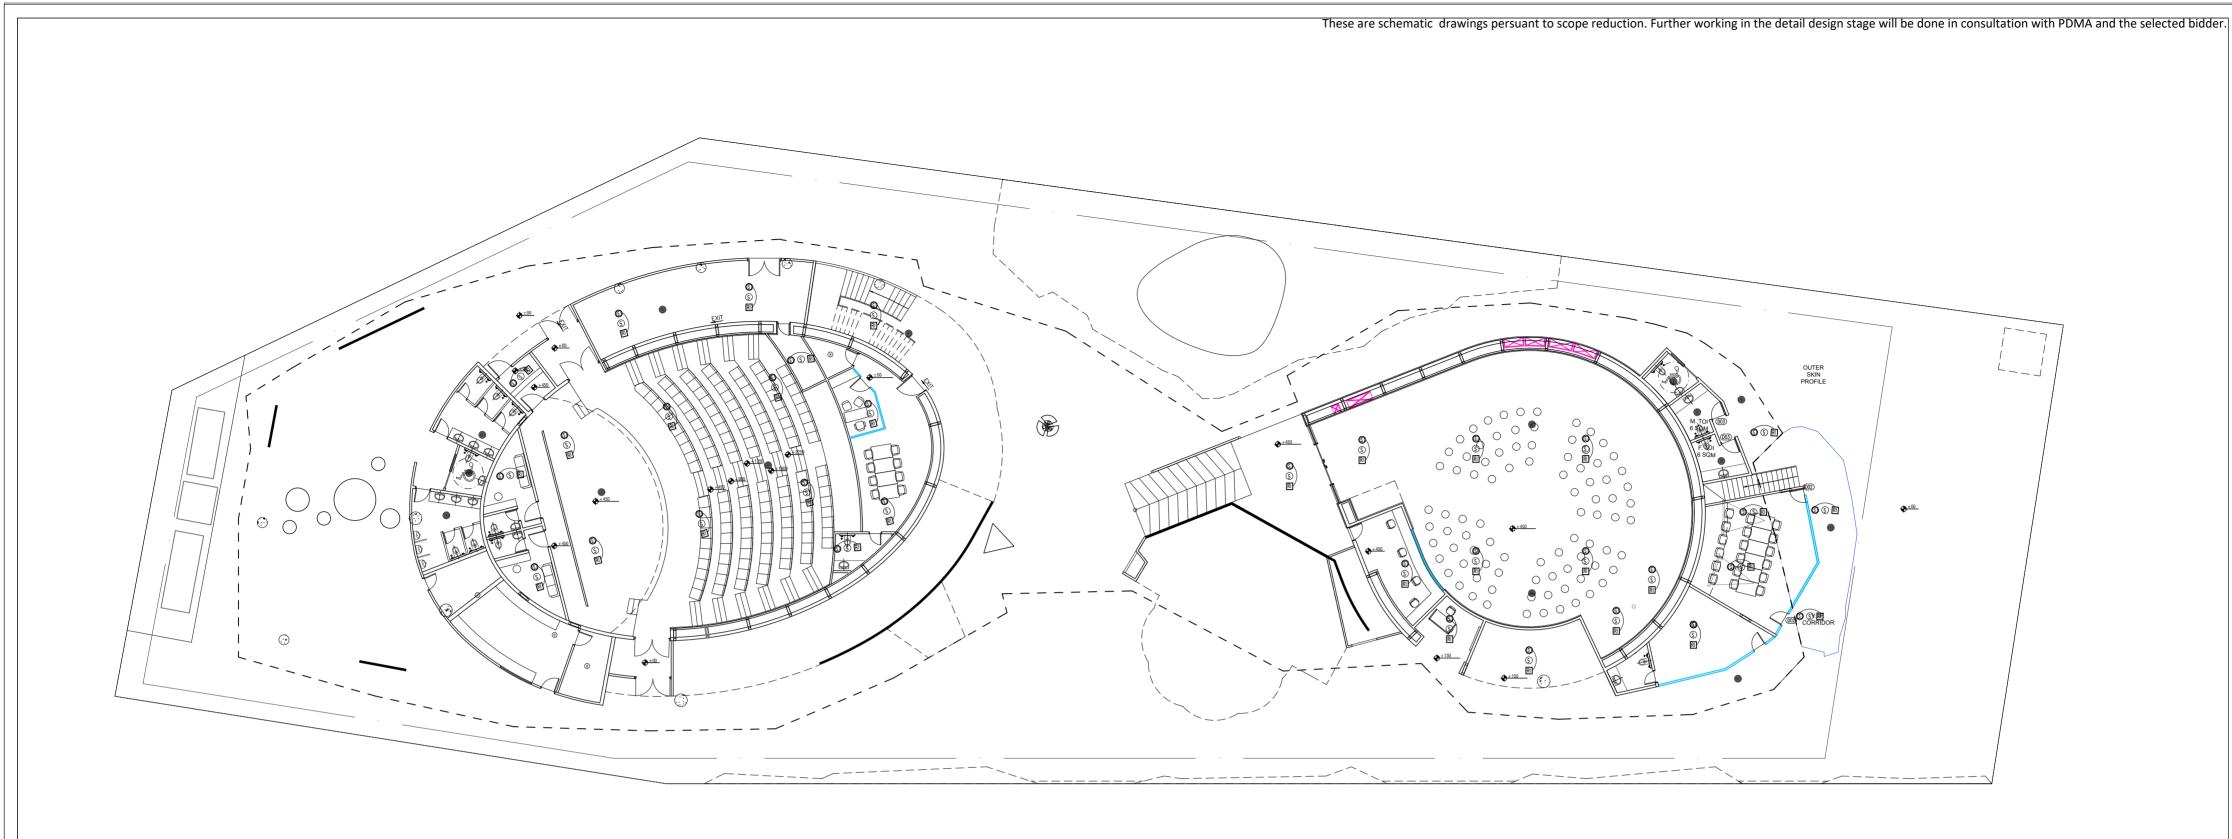
LEGEND:-	DESCRIPTION	MT.HEIGHT (MM)	
)) <u>Š</u> (((WI-FI	ON CEILING	
C	BULLET CAMERA	ON CEILING	
•<	DOME CAMERA	ON CEILING	
	DATA OUTLET	230 MM	
\Box	TELEPHONE OUTLET	230 MM	
	TELEPHONE TAG BLOCK	AS PER DETAIL	
×	T.V SPLITER	AS PER DETAIL	

GENERAL NOTES:

CLIENT
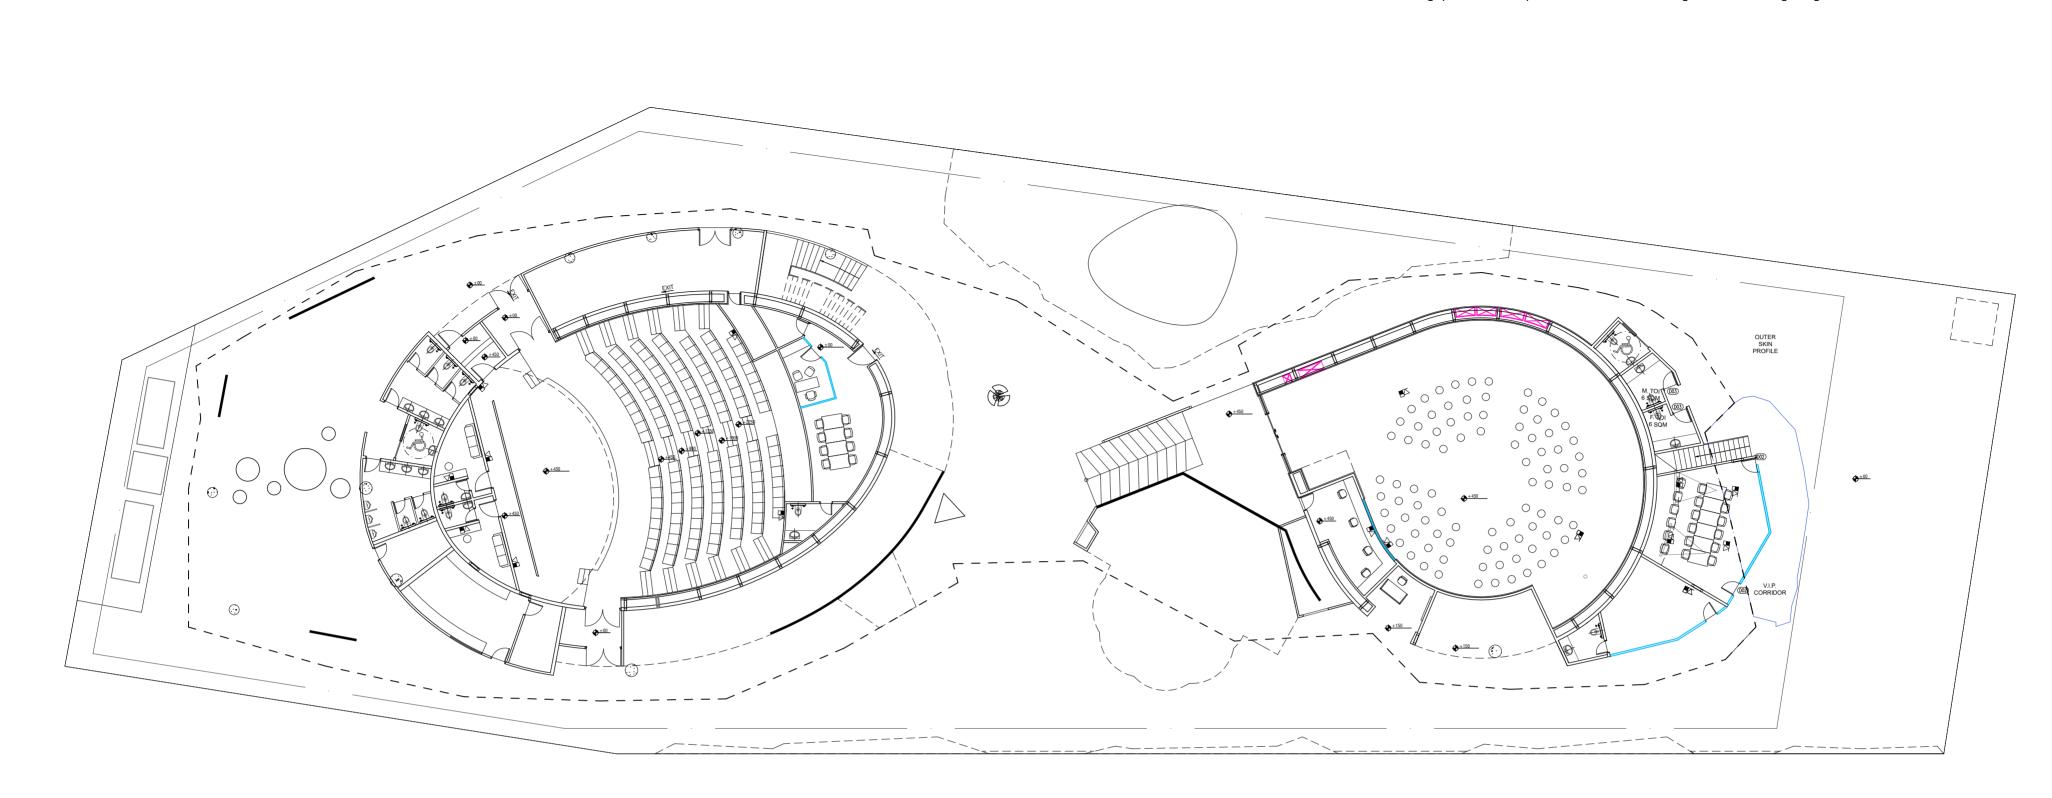
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TITLE



Γ	TLEGEND:	DESCRIPTION	IMT.HEIGHT (MM	_
	-	DESCRIPTION	MI.HEIGHI (MM)
		PA SYSTEM SPEAKER	ON CEILING	
	H	HEAT DETECTOR	ON CEILING	
	©	CONTROL MODULE	ON CEILING	
	M	MONITOR MODULE	ON CEILING	
	(3)	SMOKE DETECTOR ABOVE FALSE CEILING	ON CEILING	
	RI	RESPONSE INDICATOR	ON CEILING	
		FIRE FIGHTERS TELEPHONE JACK.	1200 MM	
	•	MANUAL CALL POINT	1200 MM	
		HOOTER CUM STROBE FLASHER	2400 MM	Ī

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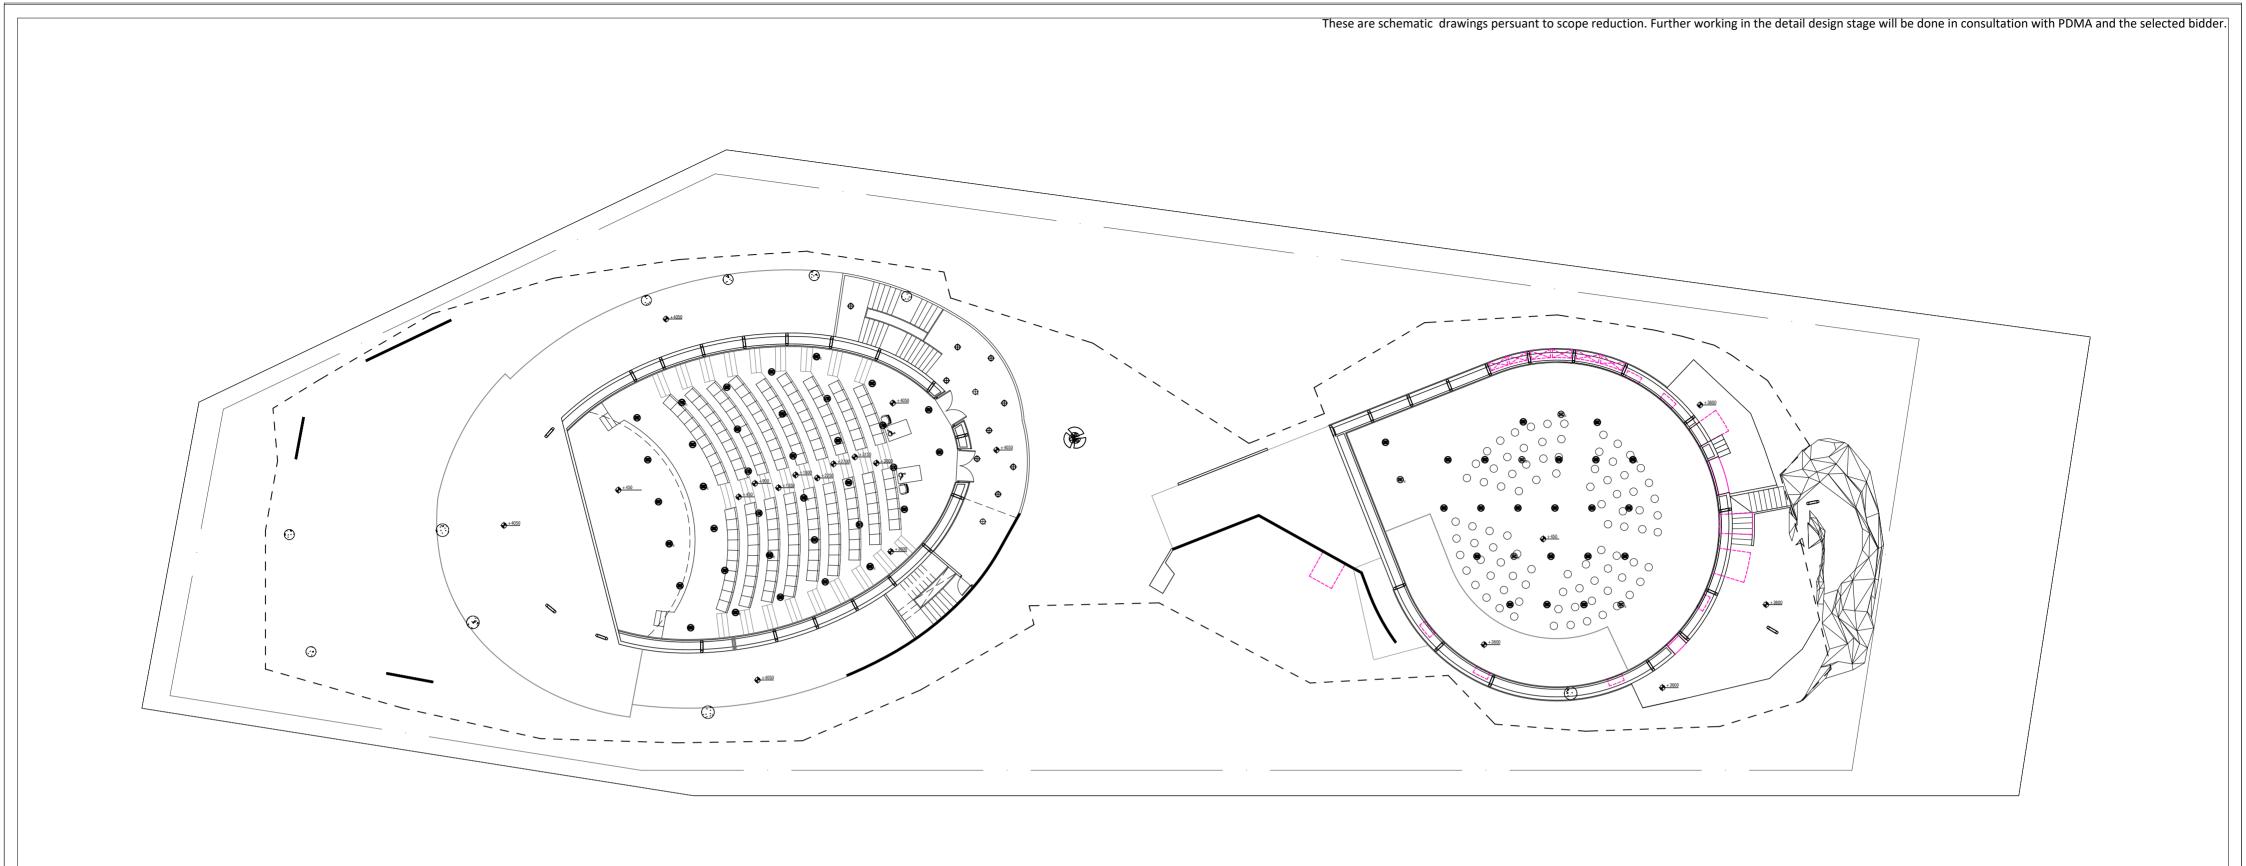
IRRESPECTIVE OF THE CONTENT INDICATED IN THE DRAWING, ALL THE BYLAWS AND NORMS APPLICABLE TO THE OSAKA MUNICIPALITY AND EXPO AUTHORITY SHALL BE FOLLOWED.

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CLIENT খ শ্রের্থন INDIA TRADE PROMOTION ORGANISATION

RELEASE FOR: FIRE & PA LAYOUT INFORMATION TENDER CONSTRUCTION AS BUILT **GROUND FLOOR** REVISION S.NO. DATE DATE-14.03.2024 REMARKS SCALE-NTS DRAWN BY-SUKHDEV CHECKED BY SHAMBUNATH DWG. NO. IPWE-DRG-ELE-104R This drawing is the property of ITPO and must not be passed on to any person or body not authorised by us to receive it nor be copied or otherwise made use either in full or in part by such person or body without our prior permission in writing.

TITLE



LEGEND:-	DESCRIPTION	MT.HEIGHT(MM) FROM FFL
₫	ONE WAY SWITCH BOARD (EMERGENCY CONTROL)	1200 MM
<u>É</u>	ONE WAY SWITCH BOARD	1200 MM
Θ	10W LED SURFACE DOWNLIGHTER	ON CEILING
	10W LED SURFACE DOWNLIGHTER (EMERGENCY CONTROL)	ON CEILING
	15W LED SURFACE DOWNLIGHTER	ON CEILING
	15W LED SURFACE DOWNLIGHTER (EMERGENCY CONTROL)	ON CEILING
	18W LED SURFACE DOWNLIGHTER	ON CEILING
≥ E	18W LED SURFACE DOWNLIGHTER (EMERGENCY CONTROL)	ON CEILING
+	10W LED RECESS DOWNLIGHTER	ON FALSE CEILING
•	10W LED RECESS DOWNLIGHTER (EMERGENCY CONTROL)	ON FALSE CEILING
\oplus	15W LED RECESS DOWNLIGHTER	ON FALSE CEILING
\	15W LED RECESS DOWNLIGHTER (EMERGENCY CONTROL)	ON FALSE CEILING
+	18W LED RECESS DOWNLIGHTER	ON FALSE CEILING
E	18W LED RECESS DOWNLIGHTER (EMERGENCY CONTROL)	ON FALSE CEILING
-	10W LED WALL MOUNTED LIGHT (IP-20)	AS PER DETAIL
	20W LED CEILING MOUNTED LIGHT	ON CEILING
	20W LED CEILING MOUNTED LIGHT (EMERGENCY CONTROL)	ON CEILING
	40W LED CEILING MOUNTED LIGHT	ON CEILING
	STEP LIGHT	600 MM
		-

CONSTRUCTION OF INDIA PAVILION FOR WORLD EXPO 2025 TO BE HELD IN OSAKA, JAPAN ON DETAILED DESIGN, ENGINEERING, PROCUREMENT AND CONSTRUCTION BASIS TOGETHER WITH SERVICES FOR INTERIOR DESIGN AND **DECORATION, OPERATION &** COMPREHENSIVE MAINTENANCE **DURING EXPO AND SUBSEQUENT** DISMANTLING OF THE INDIA PAVILION.

GENERAL NOTES:

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岩町の INDIA TRADE PROMOTION ORGANISATION

INFORMATION	TENDER	CONSTRUCTION	AS BUILT			
REVISION						

RELEASE FOR:


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VIS	ION		FIRST FLOOR	
\neg	DEMA	DVC	DATE	DATE-14 03 2024

S.NO.	REMARKS	DATE	DATE-14.03.2024	
			SCALE-NTS	
			SCALE-N13	
			DRAWN BY-SUKHDEV	
			CHECKED BY SHAMBUNATH	
			DWG. NO.	
			IPWE-DRG-ELE-101A-R	

TITLE

l	FIDOT FLOOD	
	FIRST FLOOR	
Έ	DATE-14.03.2024	
	SCALE-NTS	
	DRAWN BY-SUKHDEV	
	CHECKED BY SHAMBUNATH	
	DWC NO	_

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LEGEND:-	DESCRIPTION	MT.HEIGHT (MM)
K	6A RAW POWER SOCKET WITH SWITCH	230 MM
	6/16A RAW POWER SOCKET WITH SWITCH OUTLET	230 MM
	6/16A RAW POWER SOCKET WITH SWITCH OUTLET FOR HAND DRAWER	AS PER DETAIL

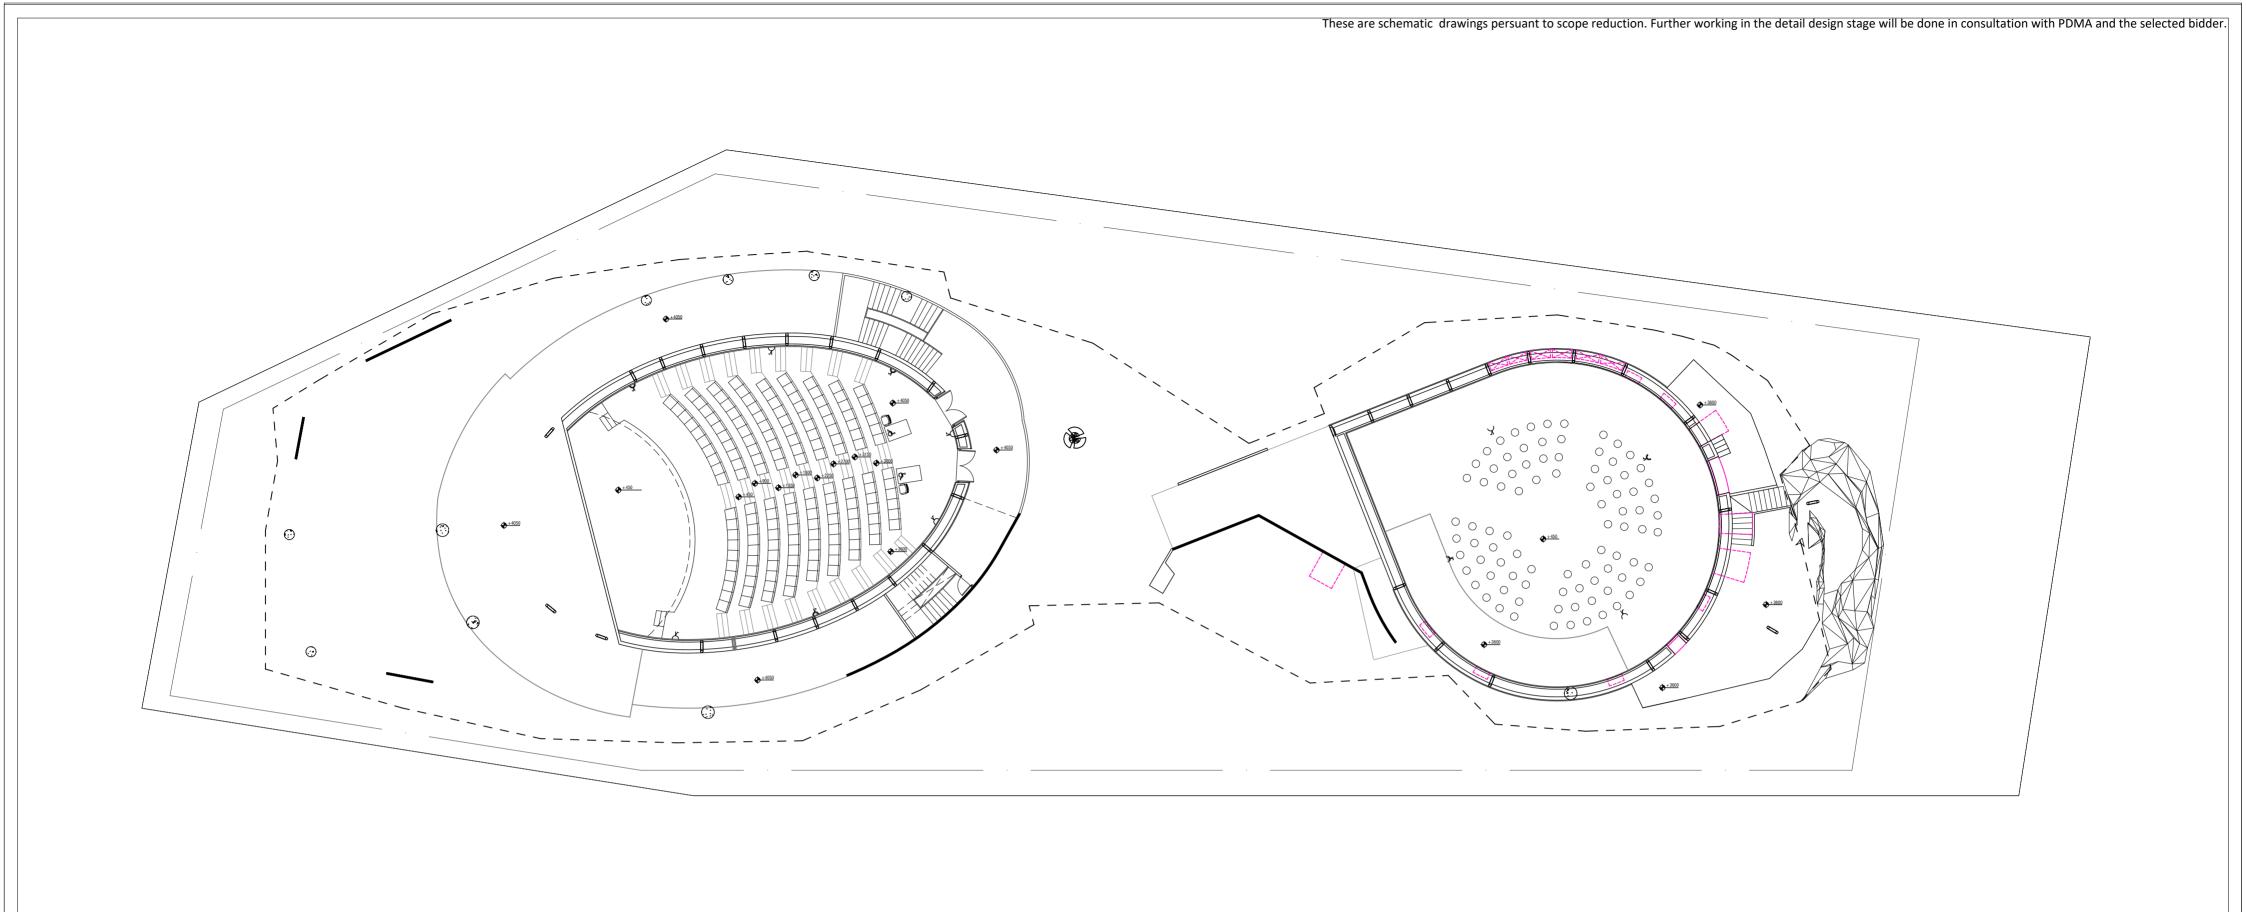CONSTRUCTION OF INDIA PAVILION FOR WORLD EXPO 2025 TO BE HELD IN OSAKA, JAPAN ON DETAILED DESIGN, ENGINEERING, PROCUREMENT AND CONSTRUCTION BASIS TOGETHER WITH SERVICES FOR INTERIOR DESIGN AND **DECORATION, OPERATION &** COMPREHENSIVE MAINTENANCE **DURING EXPO AND SUBSEQUENT** DISMANTLING OF THE INDIA PAVILION.

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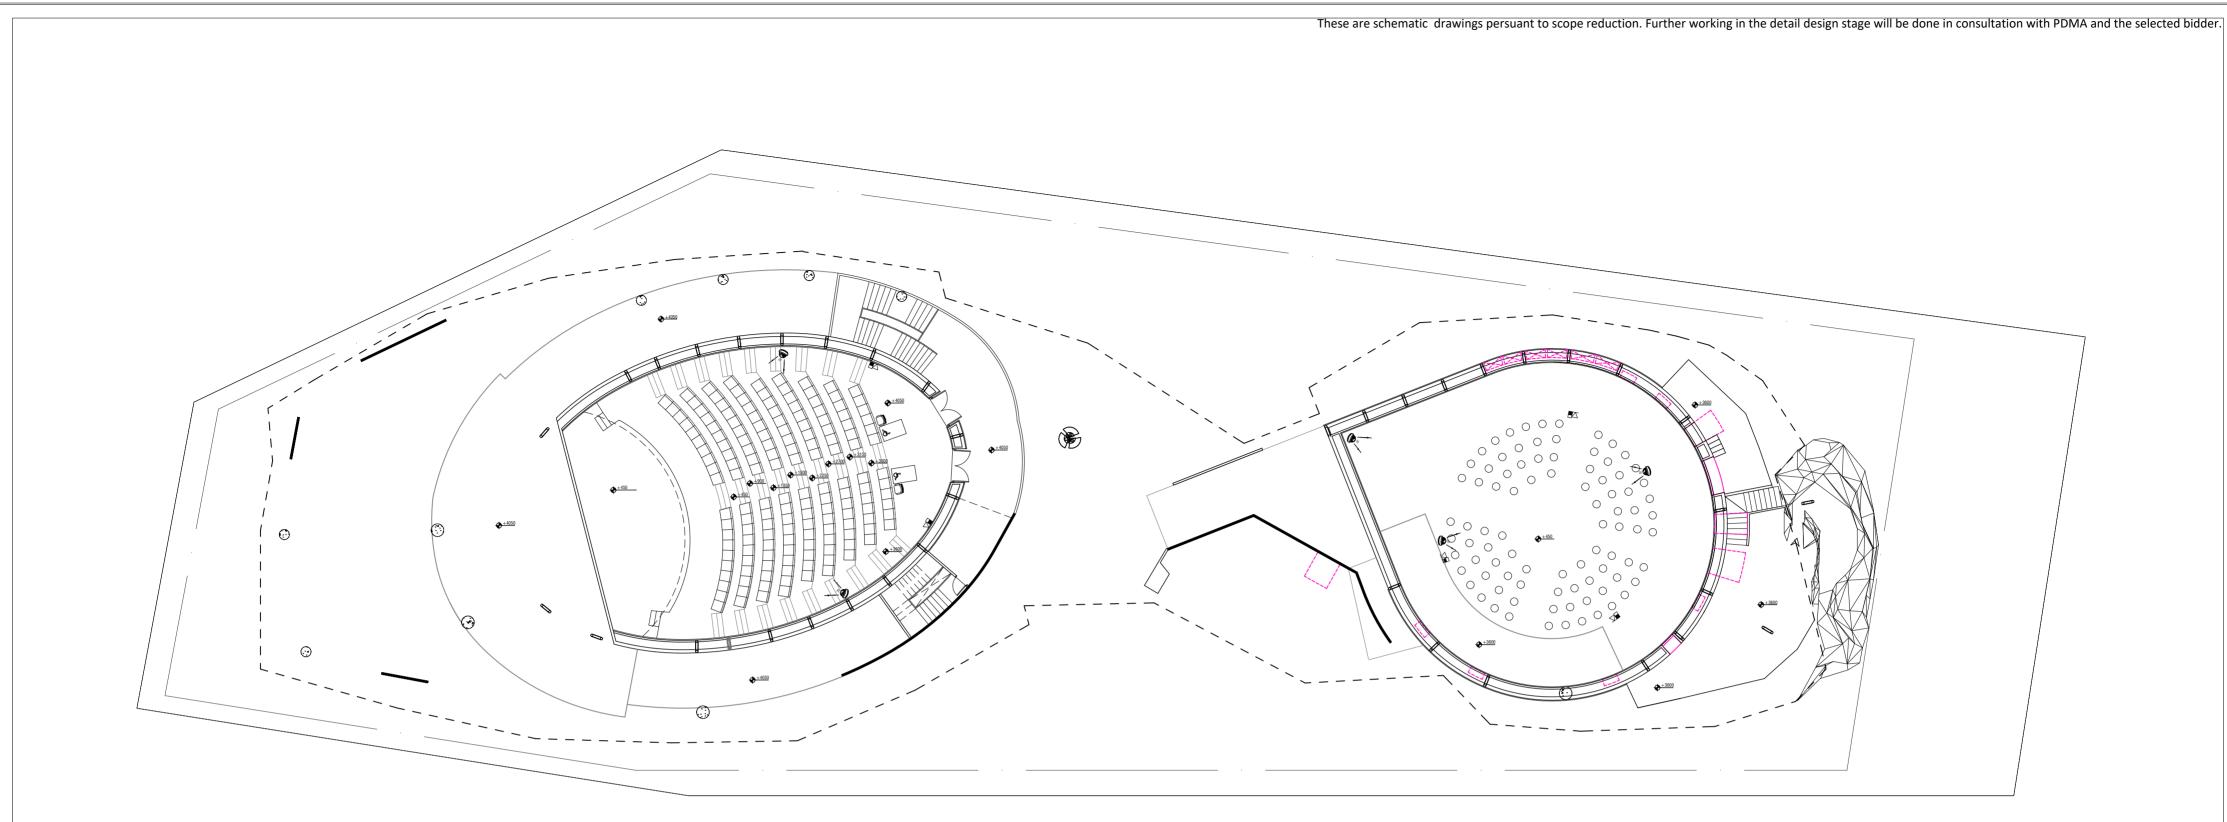
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TITLE

POWER LAYOUT
FIRST FLOOR

.NO.	REMARKS	DATE	DATE-14.03.2024	
			SCALE-NTS	
			DRAWN BY-SUKHDEV	
			CHECKED BY SHAMBUNATH	
			DWG. NO.	
			IPWE-DRG-ELE-102A-R	
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LEGEND:-	DESCRIPTION	MT.HEIGHT (MM)
n) (iii	WI-FI	ON CEILING
C	BULLET CAMERA	ON CEILING
o <	DOME CAMERA	ON CEILING
	DATA OUTLET	230 MM
\Box	TELEPHONE OUTLET	230 MM
	TELEPHONE TAG BLOCK	AS PER DETAIL
N N	T.V SPLITER	AS PER DETAIL

CONSTRUCTION OF INDIA PAVILION FOR WORLD EXPO 2025 TO BE HELD IN OSAKA, JAPAN ON DETAILED DESIGN, ENGINEERING, PROCUREMENT AND CONSTRUCTION BASIS TOGETHER WITH SERVICES FOR INTERIOR DESIGN AND **DECORATION, OPERATION &** COMPREHENSIVE MAINTENANCE **DURING EXPO AND SUBSEQUENT** DISMANTLING OF THE INDIA PAVILION.

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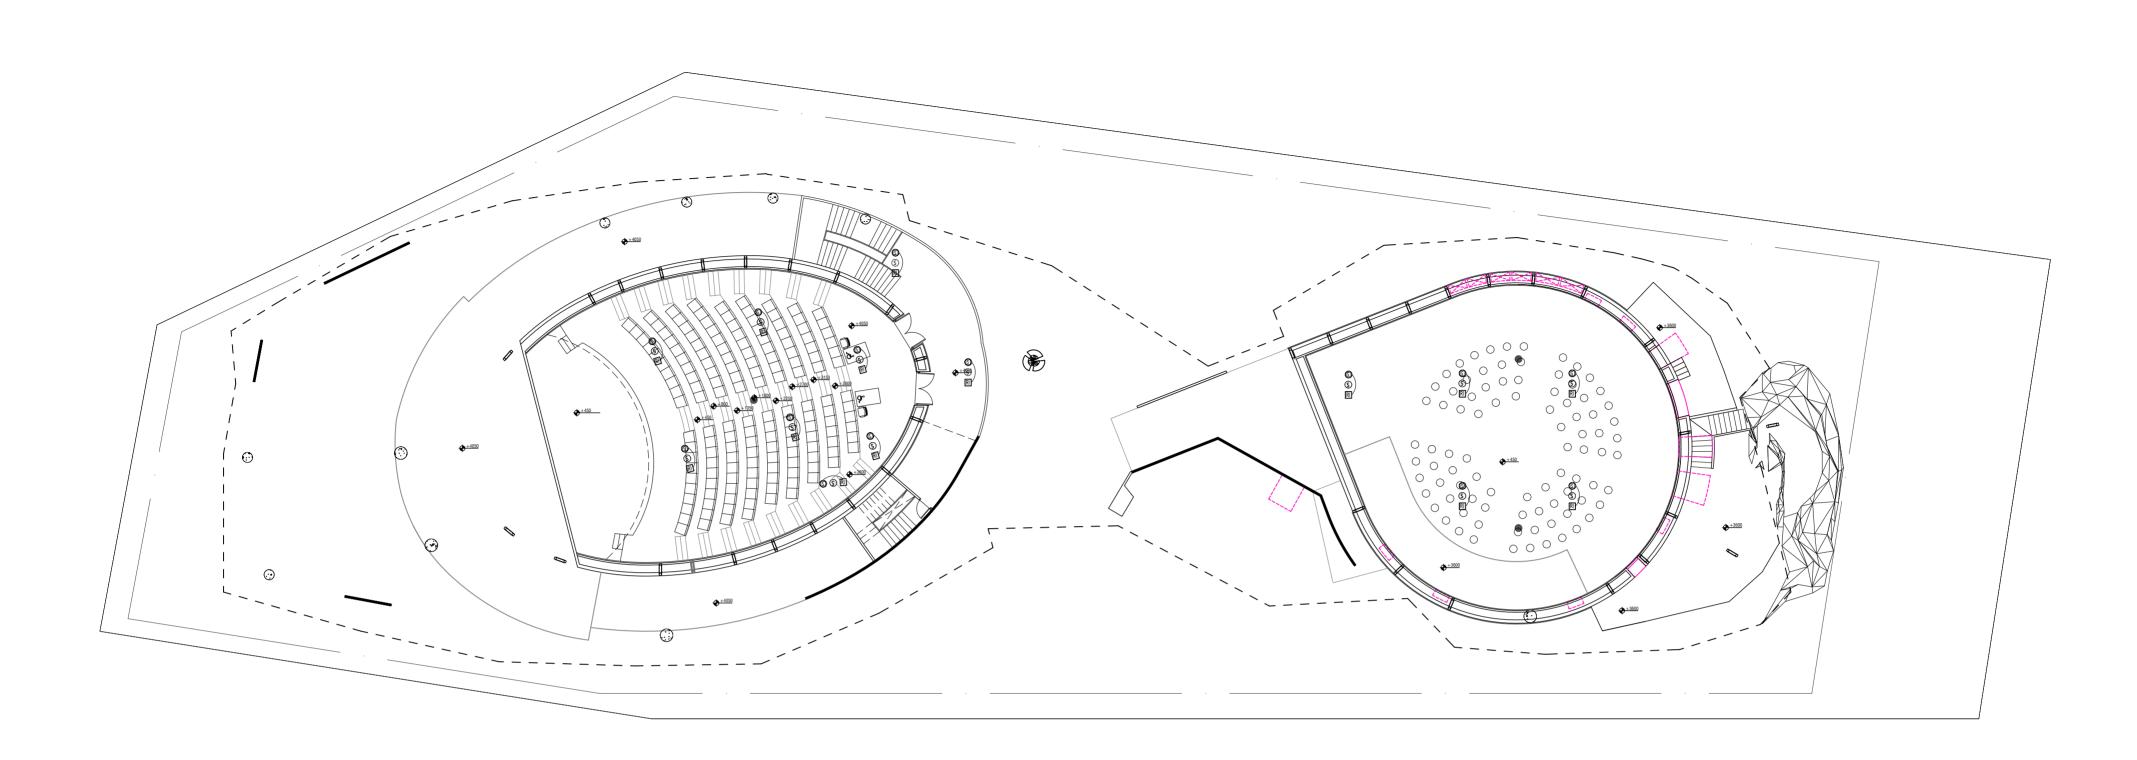
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1	INFORMATIO	FORMATION TENDER CONSTRUCTION AS B			S BUILT	ELV LAYOUT		
	REVISION					FIRST FLOOR		
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	01011		
S.NO.	REMARKS	DATE	DATE-14.03.2024
			SCALE-NTS
			DRAWN BY-SUKHDEV
			CHECKED BY SHAMBUNATH
			DWG. NO.
			IPWE-DRG-ELE-103A-R
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LEGEND:	DESCRIPTION	MT.HEIGHT	(MM)
	PA SYSTEM SPEAKER	ON CEILING	
H	HEAT DETECTOR	ON CEILING	
(C)	CONTROL MODULE	ON CEILING	
M	MONITOR MODULE	ON CEILING	
	SMOKE DETECTOR ABOVE FALSE CEILING	ON CEILING	
RI	RESPONSE INDICATOR	ON CEILING	
	FIRE FIGHTERS TELEPHONE JACK.	1200 MM	
•	MANUAL CALL POINT	1200 MM	
	HOOTER CUM STROBE FLASHER	2400 MM	

CONSTRUCTION OF INDIA PAVILION FOR WORLD EXPO 2025 TO BE HELD IN OSAKA, JAPAN ON DETAILED **DESIGN, ENGINEERING,** PROCUREMENT AND CONSTRUCTION BASIS TOGETHER WITH SERVICES FOR INTERIOR DESIGN AND **DECORATION, OPERATION &** COMPREHENSIVE MAINTENANCE **DURING EXPO AND SUBSEQUENT** DISMANTLING OF THE INDIA PAVILION.

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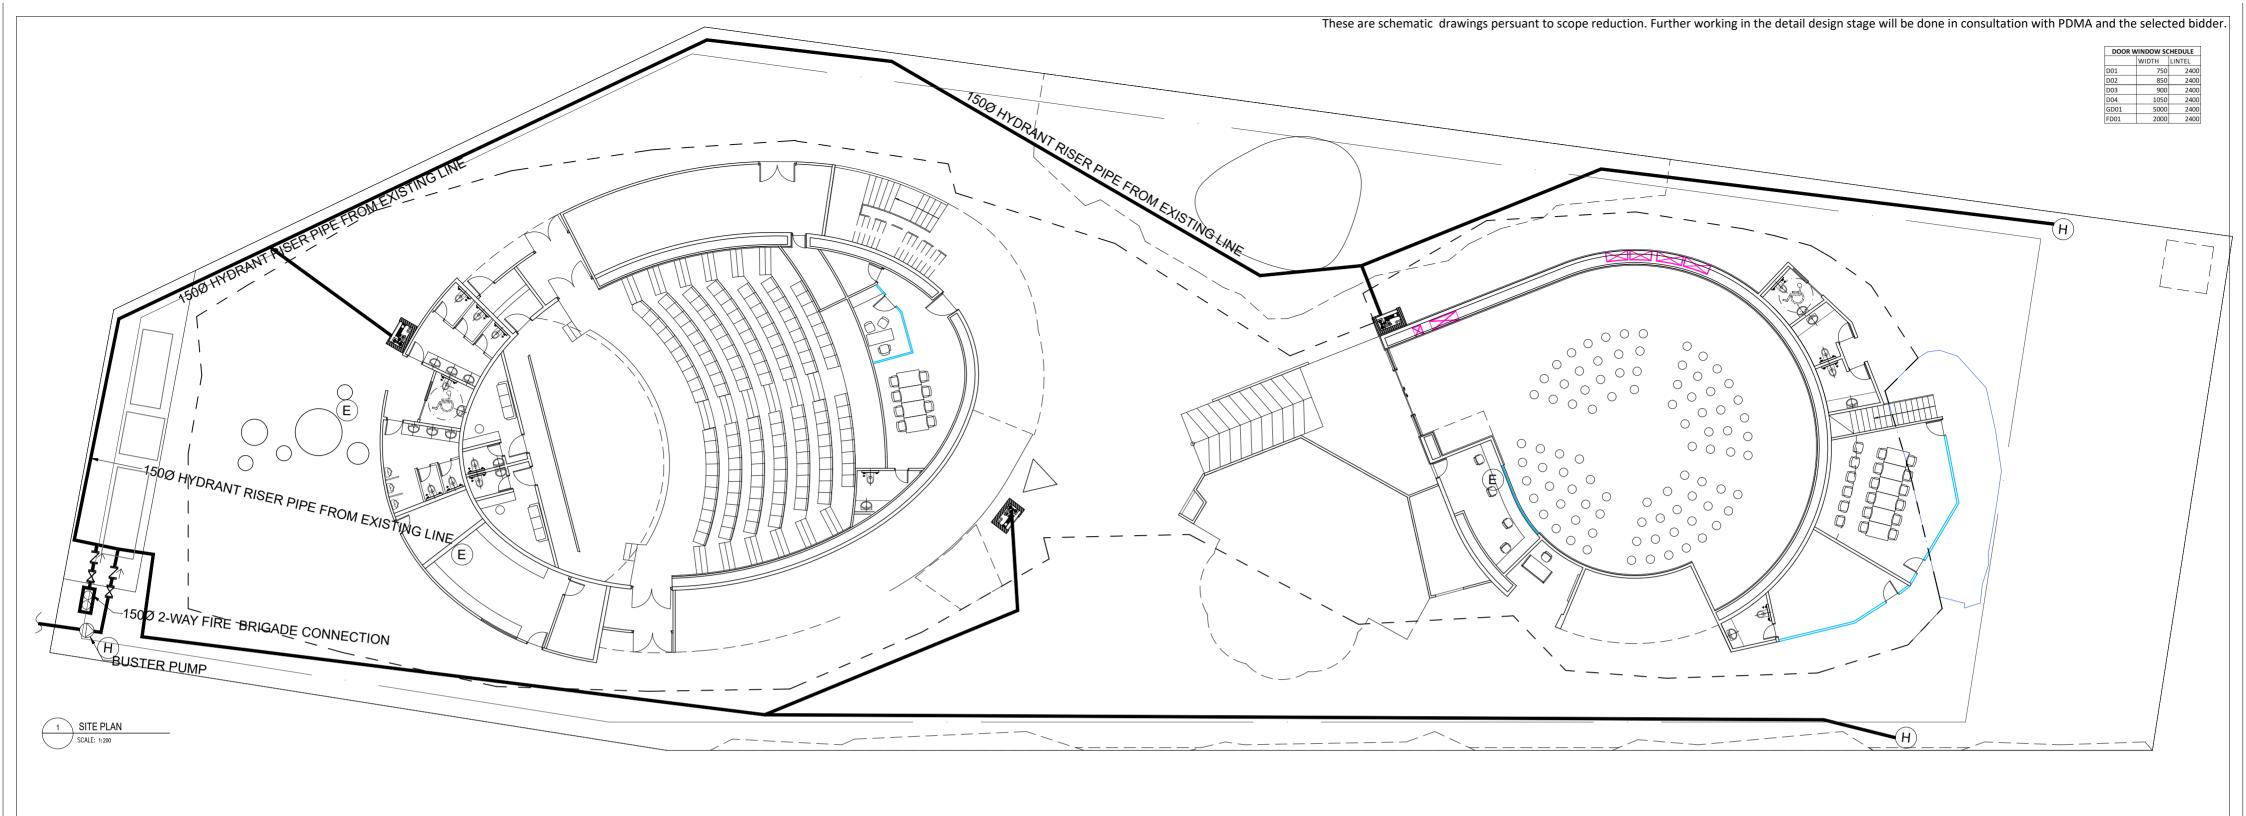
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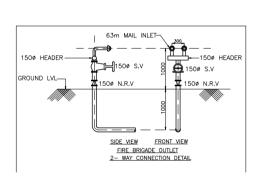
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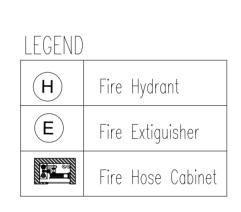
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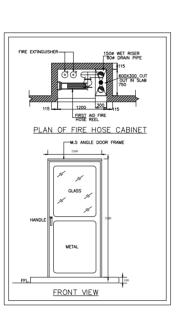
ENT	RELE	ASE FOR:		TITLE			
INDIA TRADE PROMOTION ORGANISATION		DN TENDER	CONSTRUCTION	FIRE & PA LAYOUT FIRST FLOOR			
	S.NO.	REMA	ARKS	DATE	DATE-14.03.2024		
					SCALE-NTS		
					DRAWN BY-SUKHDEV		
					CHECKED BY SHAMBUNATH		
					DWG. NO.		
					IPWE-DRG-ELE-104A-R		

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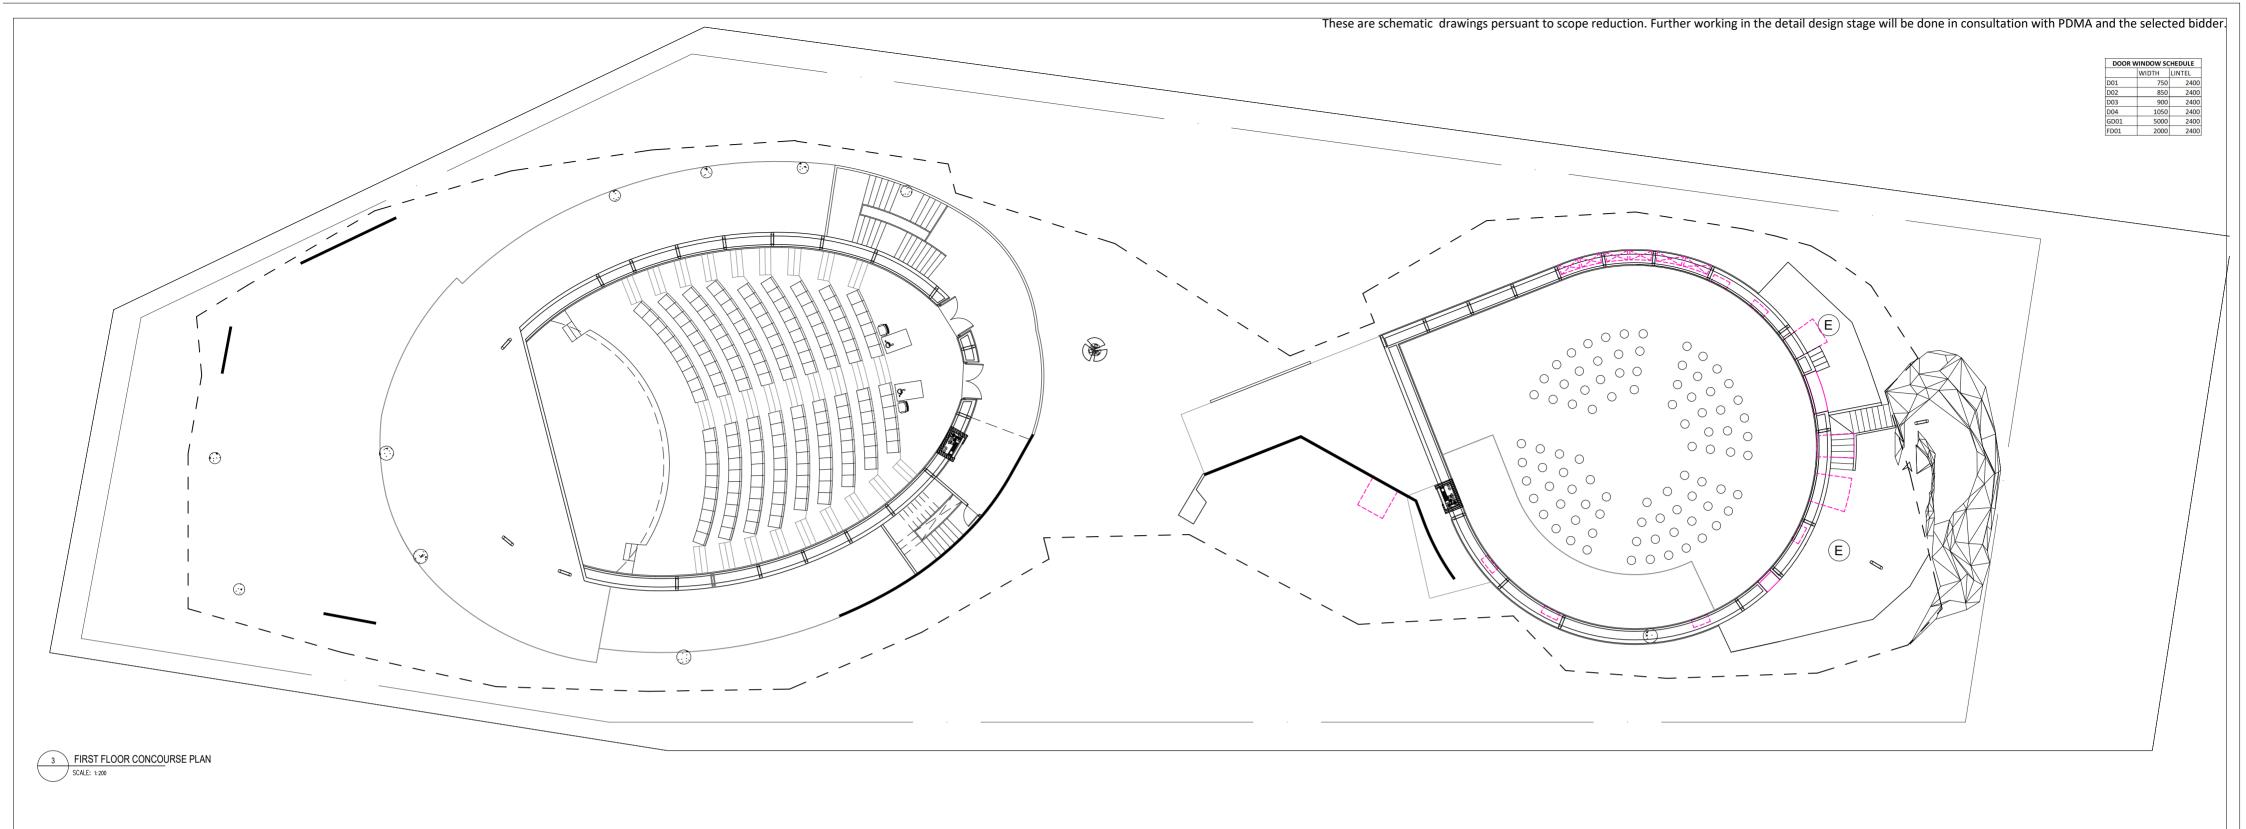









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CONSTRUCTION OF INDIA PAVILION	3. DRAWING SHALL NOT BE SCALED. ONLY WRITTEN DIMENSIONS SHOULD BE FOLLOWED.	ORGANISATION	REVISI	ON		FLAIN				
FOR WORLD EXPO 2025 TO BE HELD IN OSAKA, JAPAN ON DETAILED	4. THE DRAWINGS SHALL BE READ IN CONJUNCTION WITH ALL RELEVANT MEP.STRUCTURAL DWGS AND PROJECT SPECIFICATIONS. ANY DISCREPANCY SHOULD BE BROUGHT TO THE NOTICE OF ARCHITECT BEFORE IMPLEMENTATION.		S.NO.	REMARKS	DATE	DATE				
DESIGN, ENGINEERING, PROCUREMENT AND CONSTRUCTION	5. THE SIZES GIVEN IN DOOR WINDOW SCHEDULE IS DOOR/WINDOW OPENING SIZES, MUST INCLUDE THE MARGIN FOR PLASTER.					SCALE 1:200 (A2)				
BASIS TOGETHER WITH SERVICES	COLLETS MUST BE COORDINATED WITH INTERIOR TOILET DETAILS BEFORE CASTING. METHODOLOGY OF FIXING FOR ALL GADGET AND EQUIPMENTS SHALL BE AS PER MANUFACTURE CONSULTANT.					DRAWN BY				
FOR INTERIOR DESIGN AND DECORATION, OPERATION &	IRRESPECTIVE OF THE CONTENT INDICATED IN THE DRAWING, ALL THE BYLAWS AND NORMS APPLICABLE TO THE OSAKA MUNICIPALITY AND EXPO AUTHORITY SHALL BE FOLLOWED.					CHECKED BY				
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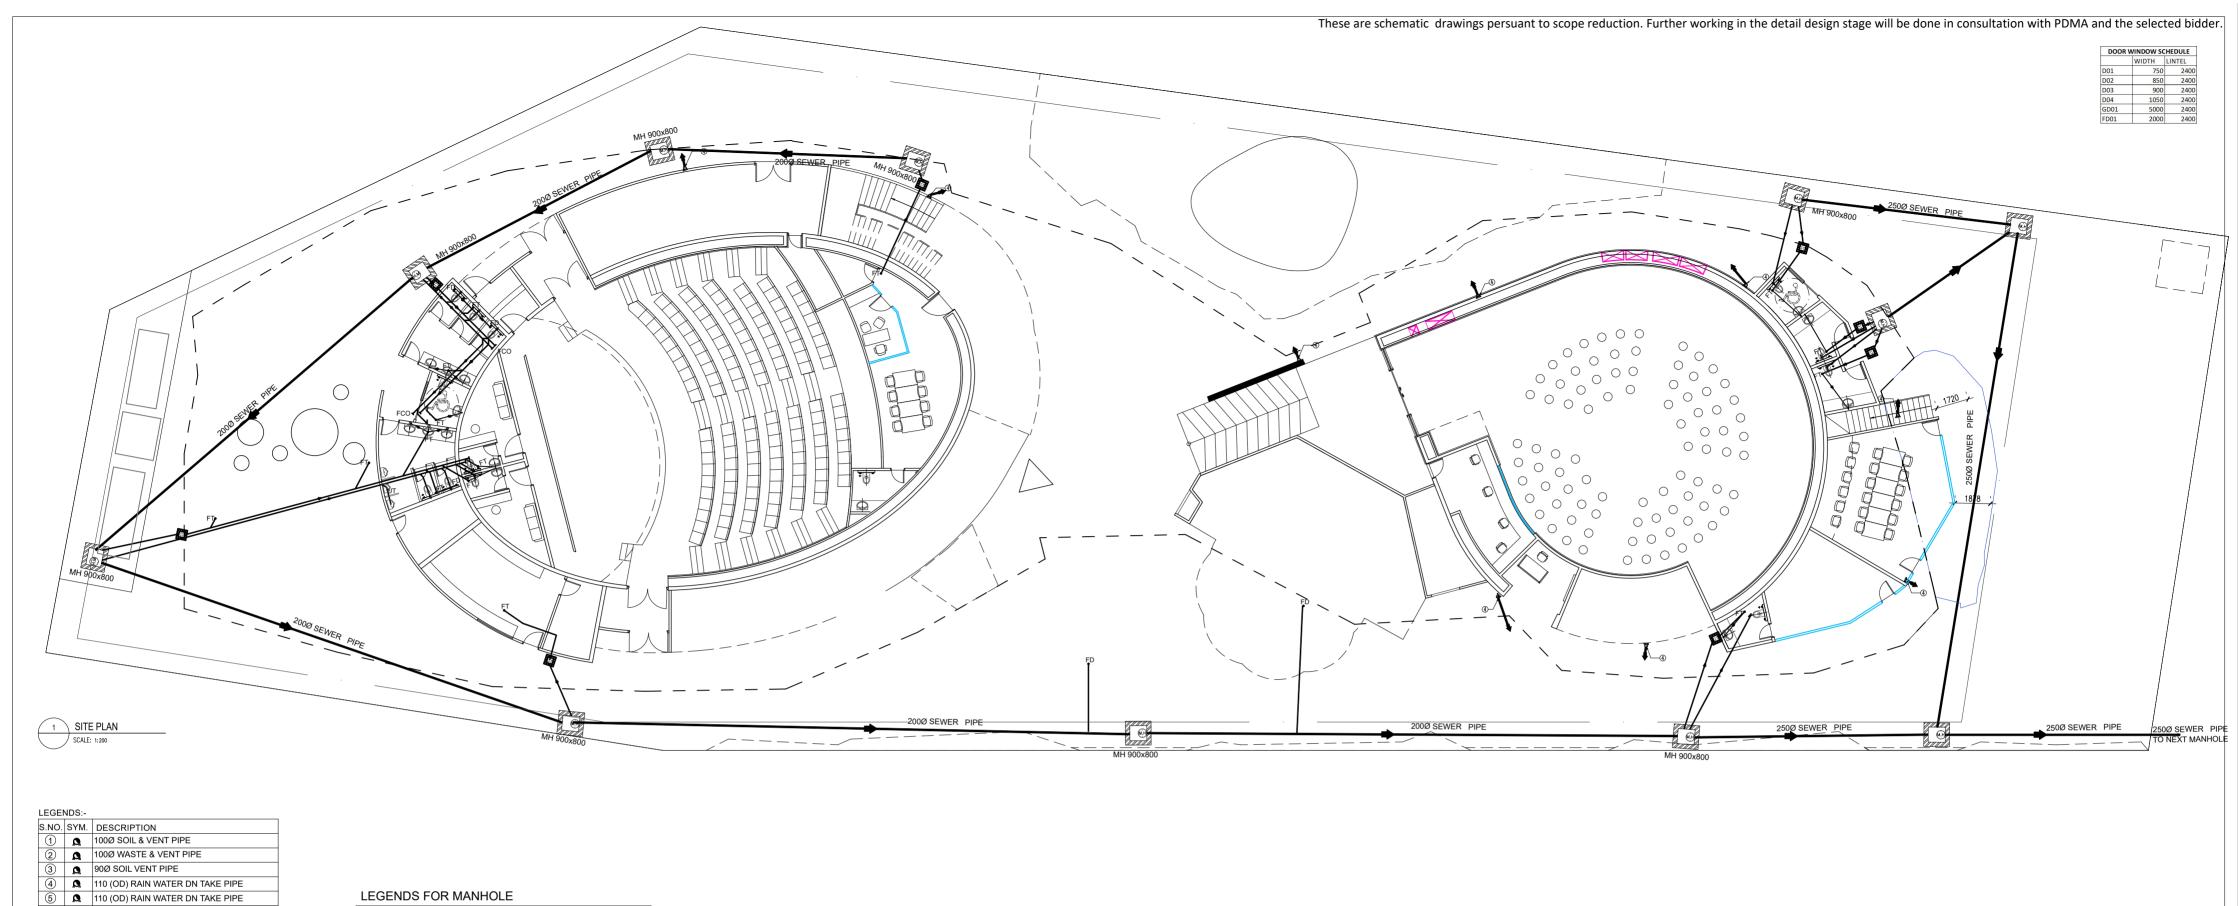







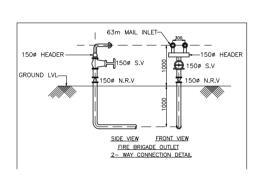
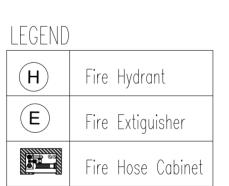
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DESIGN, ENGINEERING, PROCUREMENT AND CONSTRUCTION	5. THE SIZES GIVEN IN DOOR WINDOW SCHEDULE IS DOOR/WINDOW OPENING SIZES, MUST INCLUDE THE MARGIN FOR PLASTER.				SCALE 1:200 (A2)	
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RECTANGULAR MANHOLE SIZE AS PER DEPTH
900X800MM For depth less than 0.90mm
1200x900mm Above 0.90m & upto 2.50m

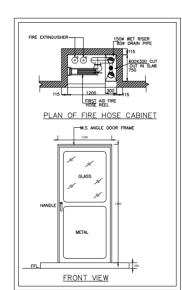CIRCULAR MANHOLE SIZE AS PER DEPTH					
900Ø	Above 0.9m & upto 1.65m				
1200Ø	Above 1.65 & upto 2.30m				
1500Ø	Above 2.30 & upto 9.00m				

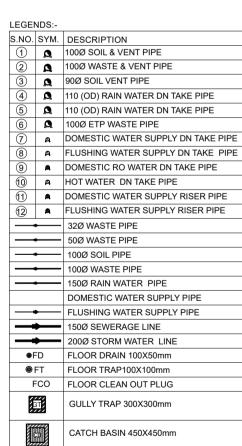PLUMBING NOTES:-						
a.	WASH BASIN TO FLOOR TRAP(FT) 32Ø WASTE PIPE					
b.	SINK TO FLOOR TRAP(FT) 40Ø WASTE PIPE					
C.	URINAL TO URINAL TRAP(UT) 40Ø SOIL PIPE					
d.	FLOOR DRAIN(FD) TO FLOOR TRAP (FT)50ØWASTE PIP					
e.	100Ø PIPE USED FOR SOIL PIPE					
f.	150&100ØPIPE USED FOR RAIN WATER PIPE					

PROJECT NAME

CONSTRUCTION OF INDIA PAVILION FOR WORLD EXPO 2025 TO BE HELD IN OSAKA, JAPAN ON DETAILED DESIGN, ENGINEERING, PROCUREMENT AND CONSTRUCTION BASIS TOGETHER WITH SERVICES FOR INTERIOR DESIGN AND DECORATION, OPERATION & COMPREHENSIVE MAINTENANCE DURING EXPO AND SUBSEQUENT DISMANTLING OF THE INDIA PAVILION.

SEWERAGE MANHOLE 900X800mm

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3. DRAWING SHALL NOT BE SCALED. ONLY WRITTEN DIMENSIONS SHOULD BE FOLLOWED.

THE DRAWINGS SHALL BE READ IN CONJUNCTION WITH ALL RELEVANT MEP, STRUCTURAL DWGS AND PROJECT
SPECIFICATIONS. ANY DISCREPANCY SHOULD BE BROUGHT TO THE NOTICE OF ARCHITECT BEFORE IMPLEMENTATION.

 THE STRUCTURE OF THE NAME OF THE STRUCTURE OF THE STRUCTUR

5. THE SIZES GIVEN IN DOOR WINDOW SCHEDULE IS DOOR/WINDOW OPENING SIZES, MUST INCLUDE THE MARGIN FOR PLASTER.

6. TOILETS MUST BE COORDINATED WITH INTERIOR TOILET DETAILS BEFORE CASTING. METHODOLOGY OF FIXING FOR ALL

GADGET AND EQUIPMENTS SHALL BE AS PER MANUFACTURE CONSULTANT.

7. IRRESPECTIVE OF THE CONTENT INDICATED IN THE DRAWING, ALL THE BYLAWS AND NORMS APPLICABLE TO THE OSAKA

MUNICIPALITY AND EXPO AUTHORITY SHALL BE FOLLOWED.

8. BEFORE CLOSING THE WALL & ROOF ALL EQUIPMENT'S FOR SERVICE FLOOR SHOULD BE PLACED IN POSITION.

S. BEFORE CLOSING THE FALSE CEILING ALL THE MEP SERVICES IN THE CEILING SHOULD BE PLACED IN POSITION AND REQUIRED TESTING SHALL BE DONE.

10. BEFORE COMPLETING THE WALL FINISHES ALL THE MEP SERVICES IN THE CEILING SHOULD BE PLACED IN POSITION AND

ALL REQUIRED SLEEVES, CUTOUTS, OPENINGS FOR MEP SERVICE SHOULD BE CONSIDERED.
 KITCHEN WALL, FLOORING AND CEILING SHOULD BE ADEQUATELY FIRE PROOF.

CLIENT

 'इंग्लि INDIA TRADE PROMOTION ORGANISATION

RELEASE FOR:

INFORMATION TENDER CONSTRUCTION AS BUILT

REVISION

S.NO. REMARKS DATE DATE

SCALE 1:200 (A2)


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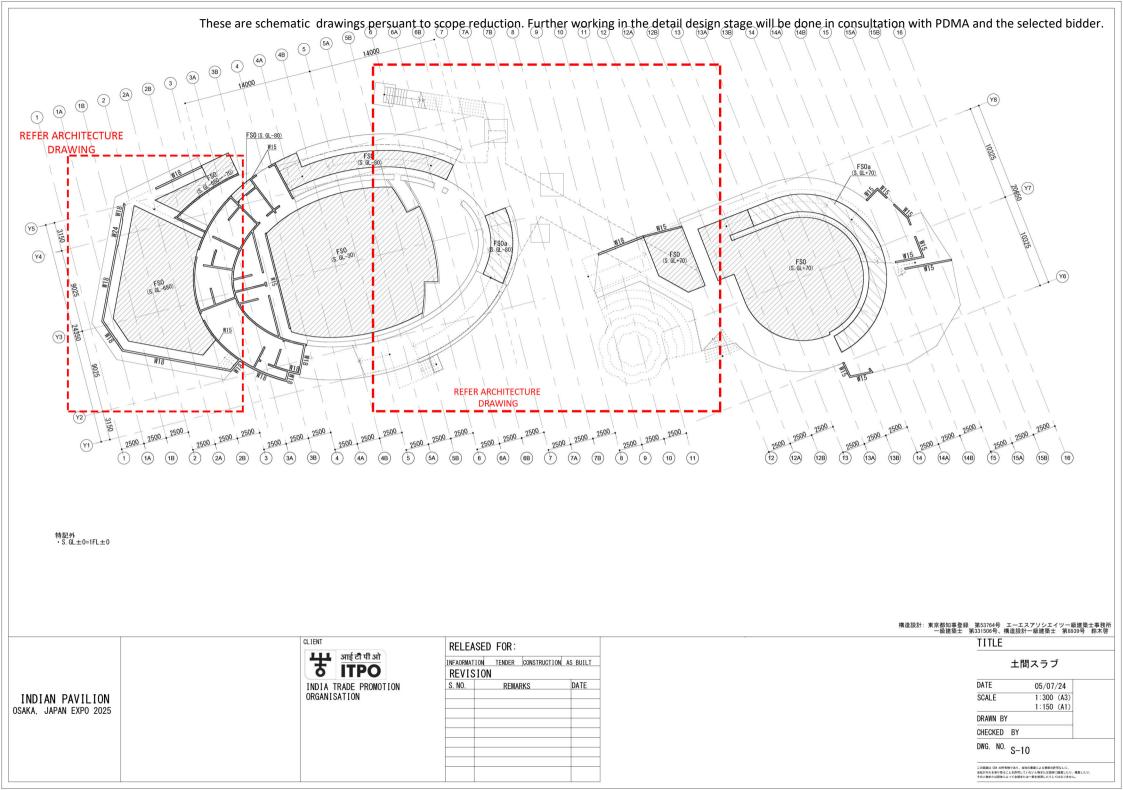
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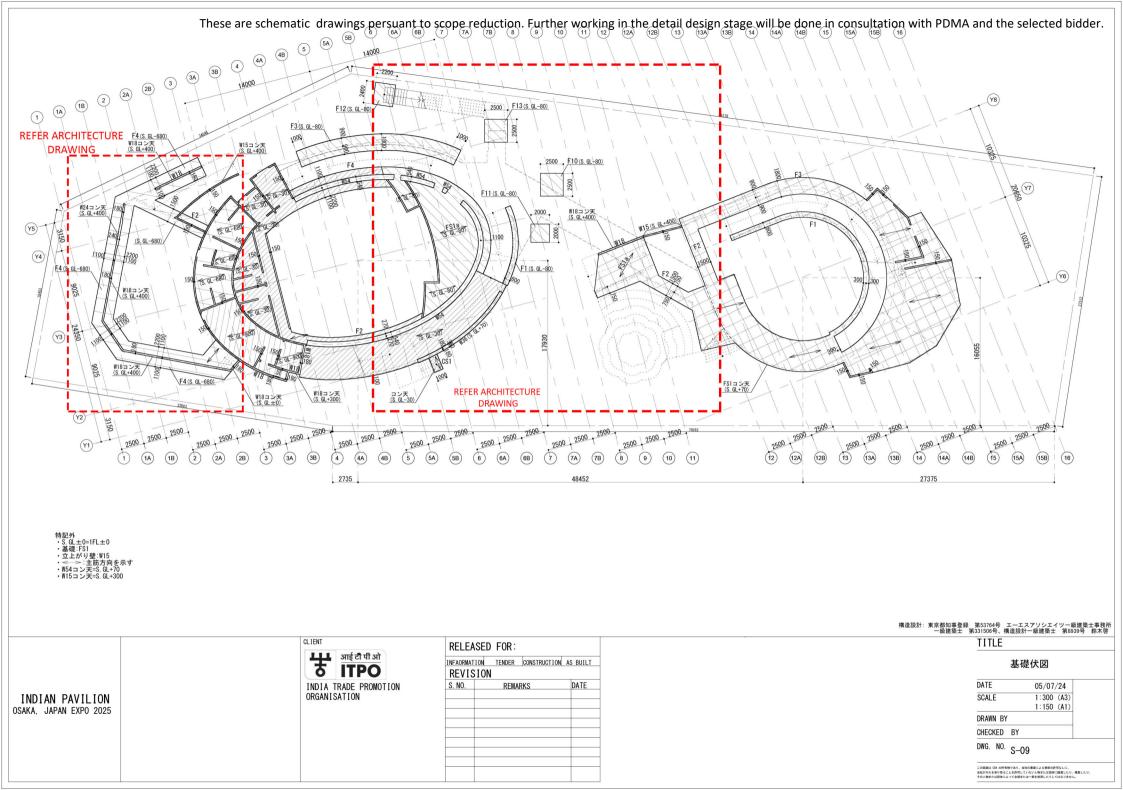
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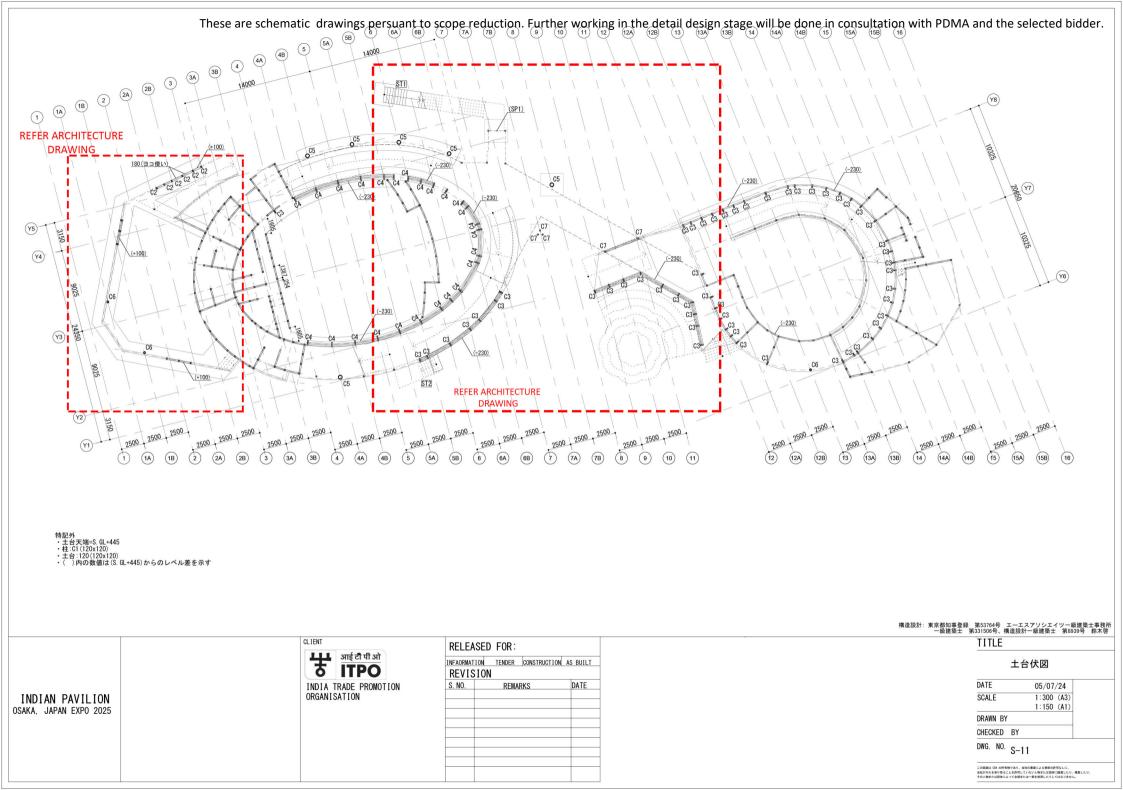
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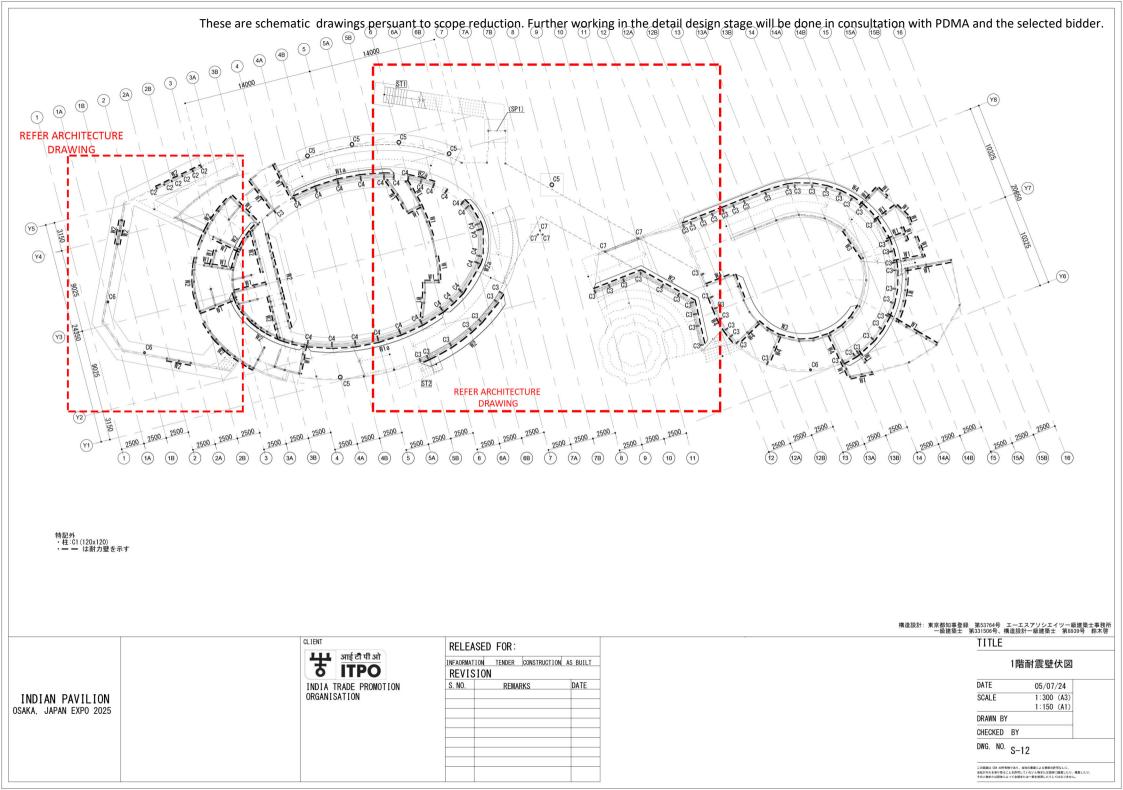
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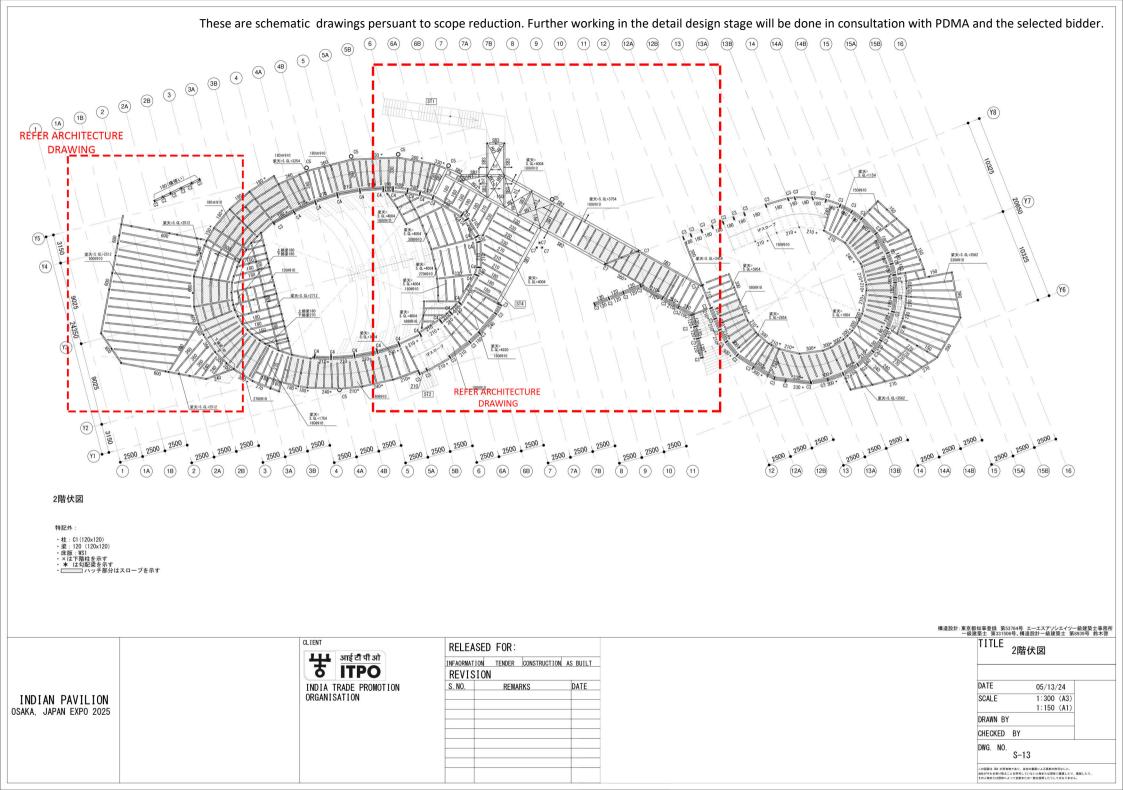











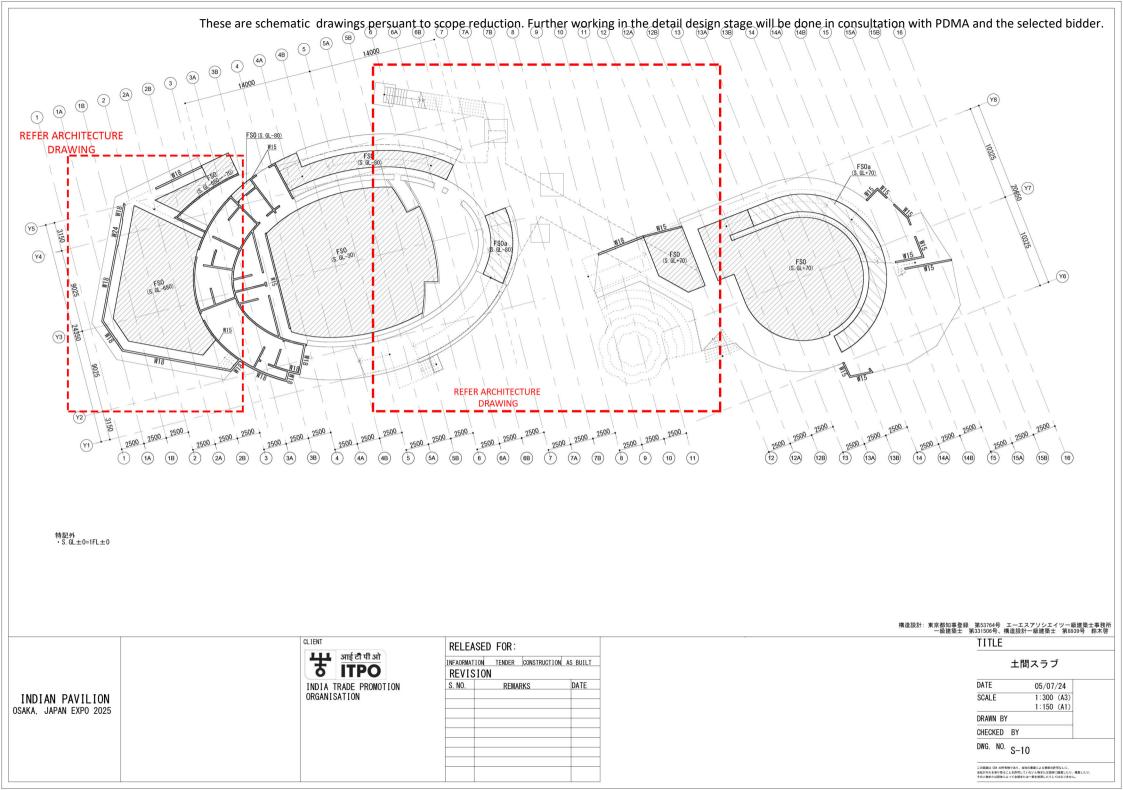

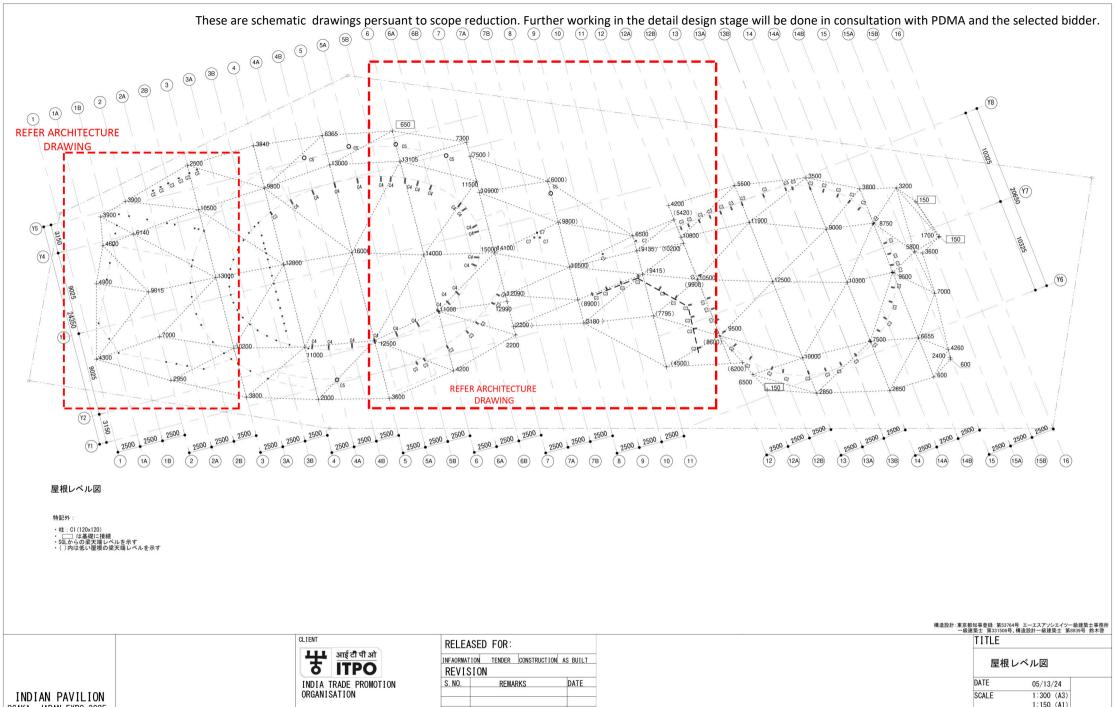

| The arms of the promotion organisation | Tender | Construction | As Built | REVISION | S. NO. | REMARKS | DATE | SCALE | 1:300 (A3) | 1:150 (A1) | DRAWN BY | CHECKED BY | DWG. NO. | S-19 | Construction | Sample of the promotion organisation | S-19 | Construction | Construction | S Built | REVISION | S. NO. | REMARKS | DATE | Construction | As Built | REVISION | S. NO. | REMARKS | DATE | Construction | Co

